# WITTERNBERG RESERVE & ROBINSONS PARK, FRANKSTON, 3199 SCHEMATIC LANDSCAPE MASTERPLAN PACKAGE REVISED IN RESPONSE TO COMMUNITY FEEDBACK NOVEMBER 2020

- SK000
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- SK102
- SK201

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- SK401

DRAWING INDEX

COVER SHEET

SITE PLAN

MASTERPLAN NORTH

MASTERPLAN SOUTH


WITTERNBERG RESERVE SCHEMATIC LANDSCAPE DESIGN

WITTERNBERG RESERVE PLAYSPACE CONCEPT

PLAYSPACE DESIGN PALETTE

PRELIMINARY COSTING/STAGING PLAN



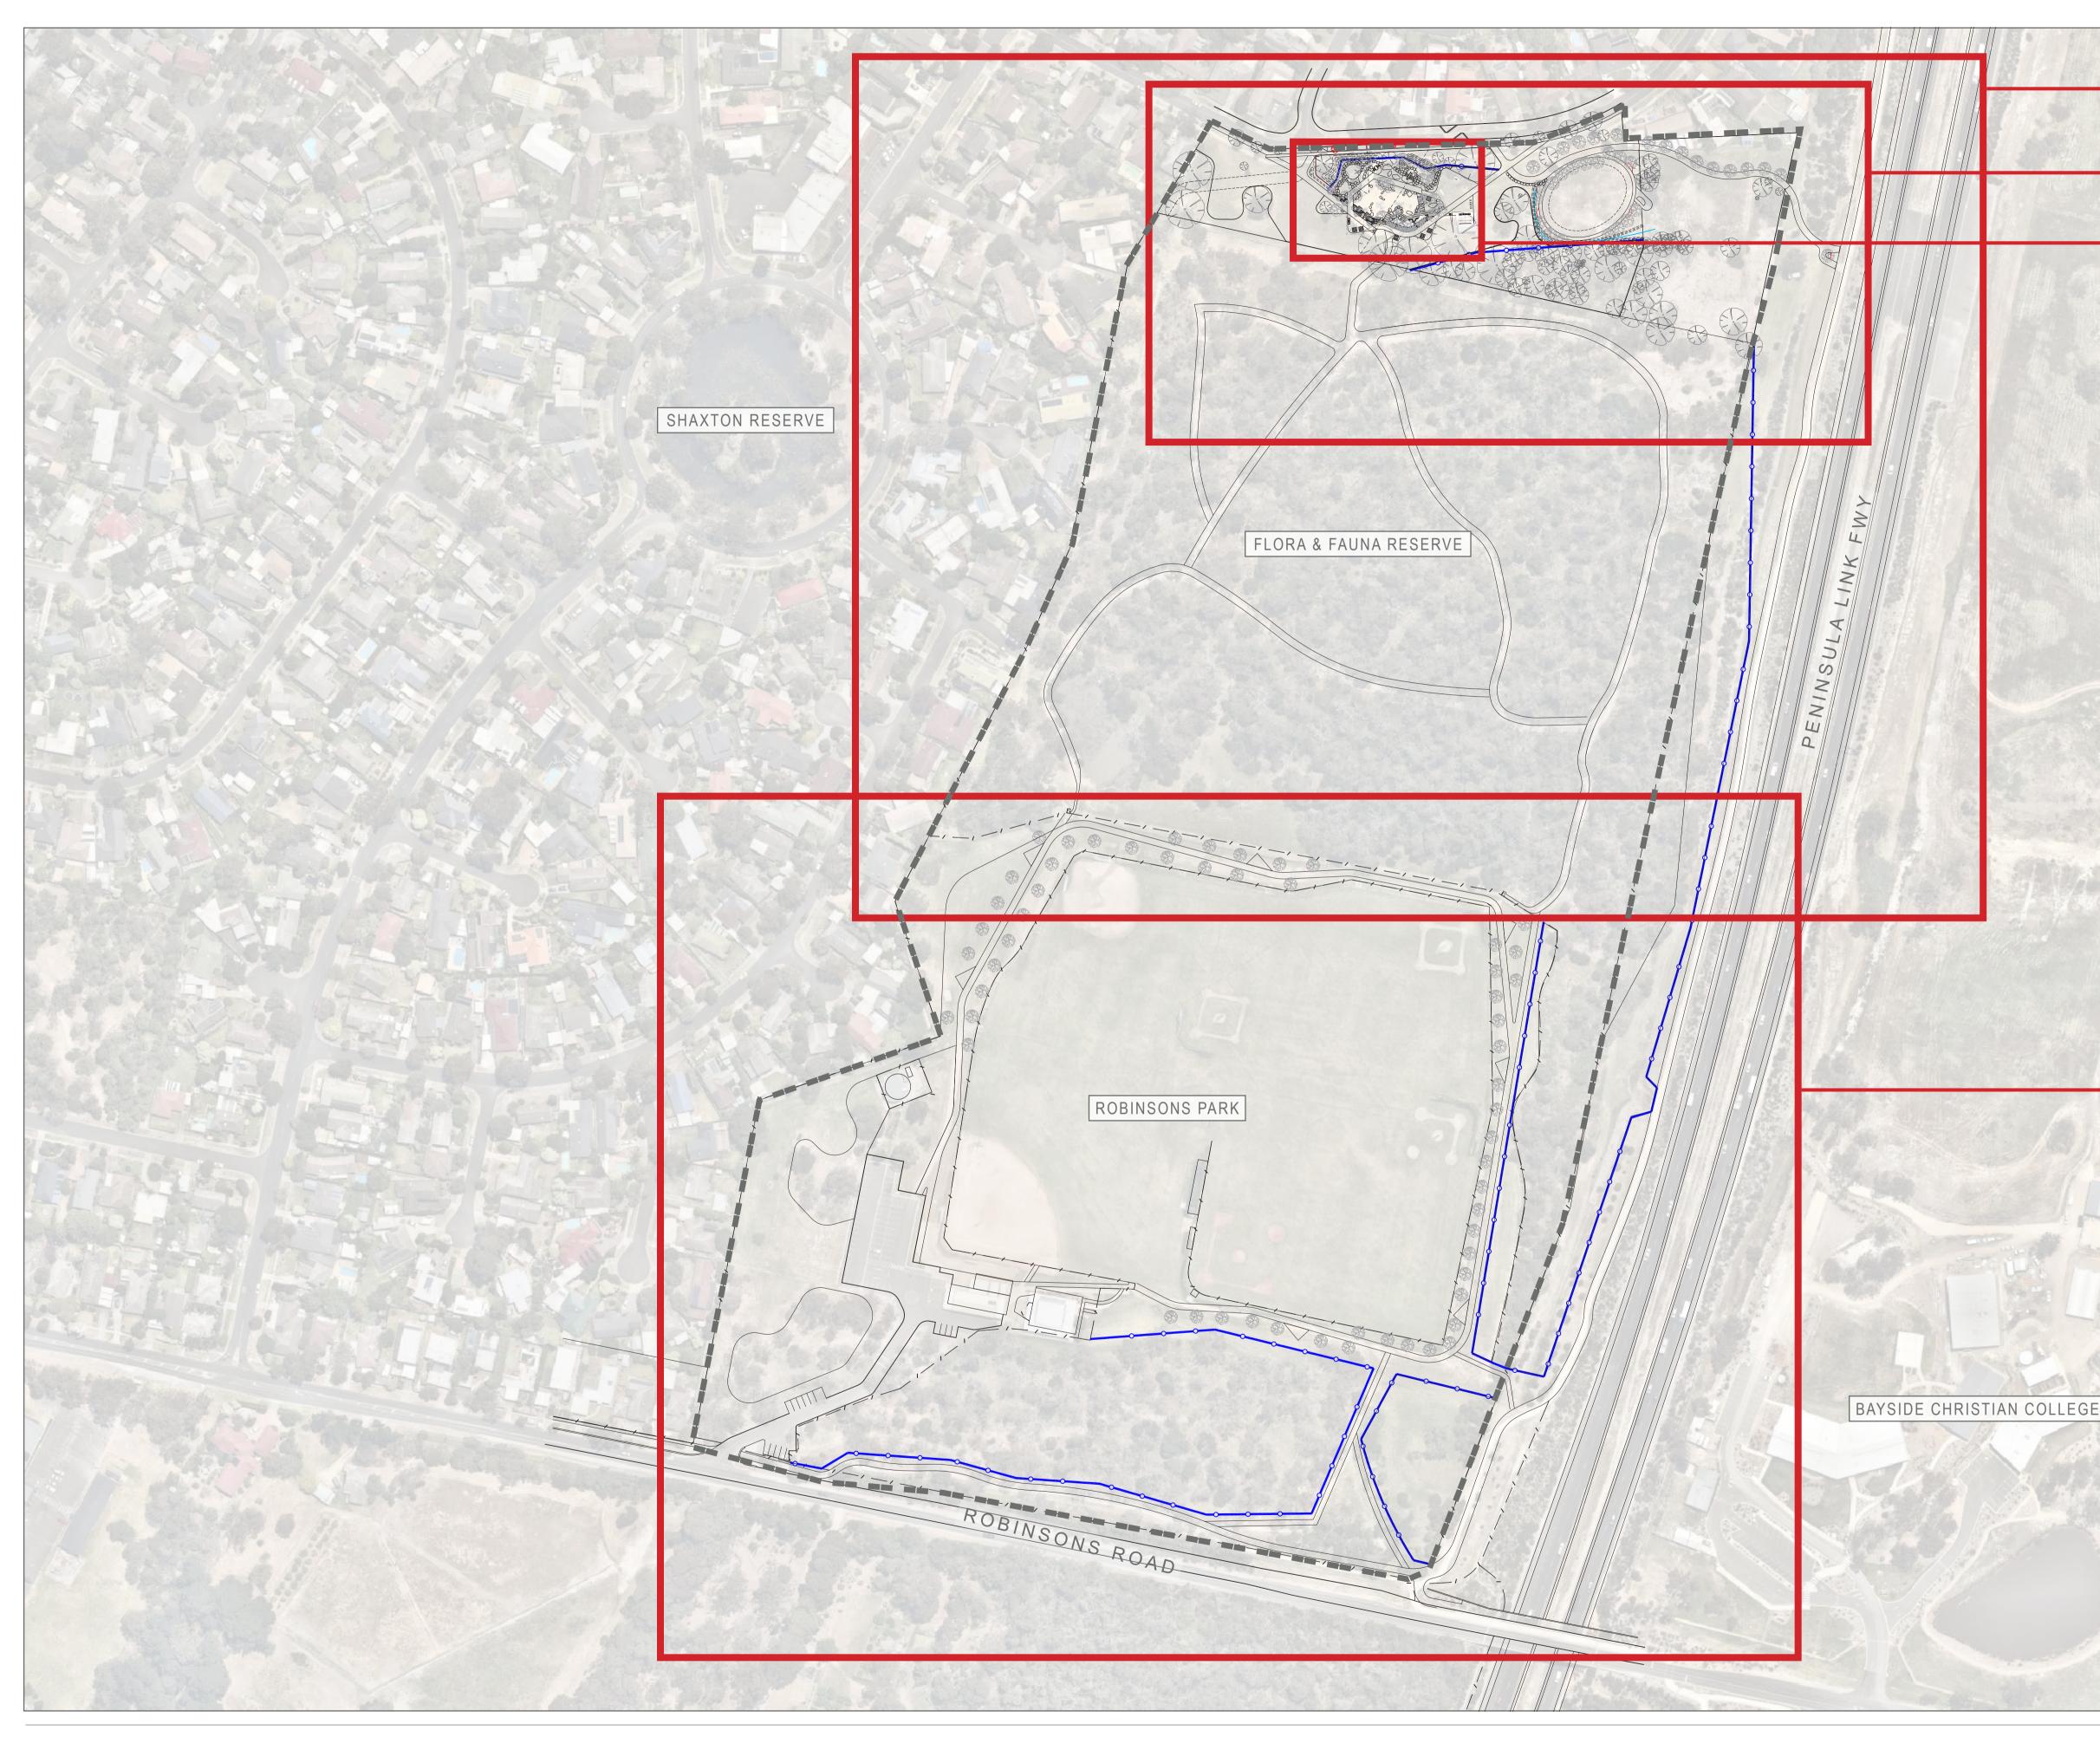







SITE IMAGE Landscape Architects WITTERNBERG RESERVE & ROBINSONS PARK, FRANKSTON SITE PLAN NOT TO SCALE

Melbourne Sydney





## SEE SHEET SK 101 MASTERPLAN NORTH

SEE SHEET SK201 WITTERNBERG RESERVE SCHEMATIC DESIGN PLAN

SEE SHEET SK202 PLAYSPACE SCHEMATIC DESIGN

FREEWAY OPEN SPACE

SEE SHEET SK 102 MASTERPLAN SOUTH

SITE IMAGE JOB NUMBER

FRANKSTON CITY COUNCIL ARCH NAME SM20372 DRAWING NUMBER SK001 ISSUE 11.11.2020 DATE



CARPARK (IF REQUIRED IN THE FUTURE) TO BE ONE WAY "SLIP-LANE" STYLE PARKING WITH PERMABLE PAVEMENTS, WSUD SWALES AND PLANTING TO SOFTEN VISUAL IMPACT.

DESIGN AND MATERIALITY OF CARPARK TO PREVENT "BURN-OUTS" AND "HOON" BEHAVIOUR.

#### R REVEGETATION WORK

Provide additional understorey vegetation where possible to support the ecology of existing remnant and planted trees within the park-scapes. These areas are to be mulched and where budgets permit, concrete edging installed to reduce weed invasion from adjacent grass areas. (Retain all existing trees)

## G OPEN GRASS

Maintain expansive areas of open grass with trees for informal recreation such as picnics and ball sports. (Retain all existing trees)







EP2

WITTERNBERG RESERVE & ROBINSONS PARK, FRANKSTON **SCHEMATIC MASTERPLAN - NORTH** 

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Melbourne Sydney



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NEW DISTRICT LEVEL

PLAYSPACE DESIGN

SCREENING PLANTS

MAINTAIN CLEAR, WIDE, MOWN SERVICE ACCESS TO NEIGHBOURING PROPERTIES TO REDUCE SNAKE RISK. IMPROVE DRAINAGE FOR MAINTENANCE ACCESS TO BOUNDARIES.



EP1.WITTERNBERG WETLAND

EP1

Future project to continue the work already started in developing a wetland in the Eastern Extent of Witternberg Reserve. Open grass swales from Witternberg reserve are to be drained to the site and additional revegetation work required. Consider planting small trees on the Northern extent to provide some privacy between the Boardwalk and the Private Properties beyond. Future Viewing Platform and Interpretive Signage is also proposed.

EP2. "OLD DAM" SITE WETLAND & WSUD SWALE

The masterplan proposes that the existing water body in the South Western corner of the Flora and Fauna Reserve be regraded and revegetated to improve the treatment of water runoff from the surrounding neighborhood and the Sports fields. This water provides permanent habitat for aquatic species and waterbirds. The overflow from the dam site which forms a swale across the southern boundary of the Flora and Fauna Reserve is also to be revegetated to treat water before it reaches the sensitive Rainbow Fern habitat site.

CONTINUED ON SHEET SK102

RELOCATE PEDESTRIAN ACCESS GATE ADJACENT TO VEHICLE ACCESS GATE TO CONNECT TO NEW CIRCUIT PATH IN ROBINSONS PARK SCALE: 1:750 @ A1 50M



CLIENT ARCHITECT 100M





### LEGEND

SITE PLAN | NOT TO SCALE

## ACCESS & PATHWAYS

FUTURE "FARMGATE" DESIGN Proposed redesign of flora and fauna Reserve Gates to consider the use of a timber "kissing gate" which is large enough for prams but not motorbikes. New surface material such as crushed rock in entrances to reduce issues with mud and puddles during we weather.

#### EXISTING "BUSHLAND TRACK

To retain the "natural" and "bushland" qualities of the flora and fauna reserve, it is preferred by Council to retain the "dirt path network through the reserve. Future maintenance is to look at realignment of the path to avoid roots and other trip hazards where possible.

#### NEW CONCRETE ACCESS PATH

New "Broom Finish" concrete paths to access the playspace. Refer to the Schematic Design for more detail on alignment.

### • • INFORMAL EXERCISE/CIRCUIT PATHS

Dromana Toppings Paths installed to provide a formal exercise circuit in locations shown on plan. Exercise circuit to have timber bollard distance markers for training & exercise guidance.

#### PROPOSED PENINSULA LINK CONNECTION PATHS (AND BOARDWALK)

The Masterplan proposes two future linkage projects to the Peninsula Link Shared Pathway. The priority is the development of the Northern Access Link through Witternberg Reserve and the Wetland site. Depending on use over time, an informal stepped pedestrian link could also be made at the South Eastern corner of Robinsons Reserve.

### **REMOVABLE BOLLARDS**

To be installed in shared path locations which double as maintenance vehicle access point

#### PEST CONTROL FENCE REALIGNMENT, EXTENSION AND REPAIR

These locations are proposed to allow for the extension of the habitat area, and are subject to future funding opportunities for associated revegetation works.



# MAINTENANCE ACCESS POINTS



#### BENCH SEAT

Proposed bench seat for quiet rest and relaxation to be sites in consultation with council environmental team

SIGNAGE PROPOSALS

#### MAIN PARK/RESERVE SIGNAGE To be installed in Accordance with Council's Signage Strategy entry signage should contain key use and safety information for the public.

DIRECTIONAL / WAYFINDING SIGNAGE Wayfinding and safety signage posts to be developed in accordance with Council's future signage strategy

#### INTERPRETIVE & EDUCATIONAL SIGNAGE PROJECTS

1. Flora and Fauna Reserve Vegetation and Wildlife Information 2. Wetland Ecology

- 3. Revegetation Project Explanation & Education
- 4. Rainbow Fern Ecology 5. Old dam aquatic ecology
- FRANKSTON CITY COUNCIL DRAWING NUMBER SK101 ARCH NAME ISSUE SITE IMAGE JOB NUMBER SM20372 DATE 11.11.2020







**SCHEMATIC MASTERPLAN - SOUTH** 

Melbourne Sydney

# WITTERNBERG RESERVE & ROBINSONS PARK, FRANKSTON

CLIENT ARCHITECT SITE IMAGE JOB NUMBER



#### LEGEND

SITE PLAN | NOT TO SCALE

#### ACCESS & PATHWAYS

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EXERCISE STATIONS TO CIRCUIT PATH

AINTENANCE ACCESS POINTS

# FUTURE STEPPED PATH ACCESS LINKS TO SLOPED EXTENT OF SITE



### \_\_\_\_ PEST CONTROL FENCE REALIGNMENT, EXTENSION AND REPAIR These locations are proposed to allow for the

extension of the habitat area, and are subject to future funding opportunities for associated revegetation works.

#### SIGNAGE PROPOSALS

MAIN PARK/RESERVE SIGNAGE







#### DIRECTIONAL / WAYFINDING SIGNAGE Wayfinding and safety signage posts to be developed in accordance with Council's future signage strategy

#### INTERPRETIVE & EDUCATIONAL SIGNAGE PROJECTS

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FRANKSTON CITY COUNCI ARCH NAME SM20372

**DRAWING NUMBER** SK102 ISSUE DATE 22.07.2020







WITTERNBERG RESERVE PLAYSPACE SCHEMATIC DESIGN

Melbourne Sydney

# WITTERNBERG RESERVE & ROBINSONS PARK, FRANKSTON

CLIENT ARCHITECT SITE IMAGE JOB NUMBER



SITE PLAN | NOT TO SCALE

1	DRY CREEKBED WITH NATIVE TREE PLANTING AND ROCKWORK
2	ADVENTURE PLAY ENSURE INTEGRATED SHADE STRUCTURES TO GROUND
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FRANKSTON CITY COUNCI ARCH NAME SM20372

SK201 DRAWING NUMBER ISSUE DATE 22.07.2020









WITTERNBERG RESERVE PLAYSPACE CONCEPT

Melbourne Sydney

# WITTERNBERG RESERVE & ROBINSONS PARK, FRANKSTON

CLIENT ARCHITECT SITE IMAGE JOB NUMBER



SITE PLAN | NOT TO SCALE

- ENSURE INTEGRATED SHADE STRUCTURES TO PLAY-

- BASKETBALL RING AND SHOOTING CIRCLE

- SEMI-PERMEABLE SCREENS FOR PASSIVE SURVEILLANCE OF TOILETS X 2 EXTERNAL

FRANKSTON CITY COUNCI ARCH NAME SM20372

SK202 **DRAWING NUMBE** ISSUE DATE 22.07.2020

# THE FRANKSTON CITY COUNCIL PLAYSPACE DESIGN PALETTE

The playspace at Witternberg Reserve will build upon the success of recently completed playspaces in Frankston City Council. It is Council's intent that the playspace embrace its natural backdrop, and be developed in a subtle and natural material and colour palette to compliment the bushland beyond. It is also hoped that this playspace will offer more to a broader demographic within the community and invite teens and seniors to make the most of this amazing open space.

## MATERIALS

Council have a simple material palette which ensures that playspaces are easily maintained

# EDGING DETAILS

Landscape edges in playspaces are important for maintaining our parks; however they can also be interactive seating and play elements









PLAYSPACE DESIGN PALETTE

Melbourne Sydney

## PLAY ELEMENTS

Expand on play elements for a greater diversity of ages, including the incorporation of a basketball ring, parkour logs and seniors exercise equipment options



## PARK FURNITURE

Council is working on an attractive, low maintenance furniture palette for its playspaces. This proposal will also explore options for custom recycled plastic furniture



# WITTERNBERG RESERVE & ROBINSONS PARK, FRANKSTON

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SK301