# Landscape Issue for Construction Documentation Package

# YARRALUMLA RESERVE

**CLIENT CONTACT:** 

Frankston City Council

**Garry Woolard** 

Senior Project Manager

e: Garry.Woolard@frankston.vic.gov.au

p: 03 9768 1550

m: 0418 364 411

PROJECT ADDRESS:

Yarralumla Dr, Langwarrin VIC 3910

## **CONSULTANT CONTACT:**

## Pollen Studio P/L

**Chris Cham** 

Senior / Registered Landscape Architect

e: chris@pollenstudio.com.au

p: 03 9329 7548

m: 0433 569 268

#### Olivia Bloch

Landscape Architect

e: olivia@pollenstudio.com.au

p: 03 9329 7548

## PROJECT PHASE:

## **Construction Support**

02.02.2023 Issue: 1

## DRAWING REGISTER:

POLLEN

BRUNSWICK - Siteworks

Pollen Studio Pty Ltd - Landscape Architects

Studio 1 | Level 1 | 33 Saxon Street VIC 3056

03 9329 7548 | pollen@pollenstudio.com.au

pollenstudio.com.au | ABN 45 494 020 124

DRAWING NO	. DRAWING TITLE	SHEET	REV.
LCD-000	Cover Page	1	Α
LCD-100	Performance Notes	2	Α
LCD-101	Performance Notes	3	Α
LCD-200	Existing Conditions and Demolition Plan	4	Α
LCD-300	Grading, Drainage & Levels Plan	5	Α
LCD-301	Grading, Drainage & Levels Plan	6	Α
LCD-302	Grading, Drainage & Levels Plan	7	Α
LCD-400	Set Out Plan	8	Α
LCD-401	Set Out Plan	9	Α
LCD-402	Set Out Plan	10	Α
LCD-500	Surfaces & Finishes Plan	11	Α
LCD-501	Surfaces & Finishes Plan	12	Α
LCD-502	Surfaces & Finishes Plan	13	Α
LCD-600	Furniture & Equipment Plan	14	Α
LCD-601	Furniture & Equipment Plan	15	Α
LCD-602	Furniture & Equipment Plan	16	Α
LCD-700	Planting Plan	17	Α
LCD-701	Planting Plan	18	Α
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LCD-904	Landscape Details	27	Α
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## FOR CONSTRUCTION

**PROJECT** 

Capital Works

YARRALUMLA RESERVE

Frankston City Council

30 Davey Street, Frankston VIC 3199


**ACKNOWLEDGEMENT OF COUNTRY:** 


We acknowledge and respect Traditional Owners as the original custodians of Victoria's land and waters that were never ceded. We honour elders past and present whose knowledge, connection and wisdom has ensured the continuation of culture and care for Country for tens of thousands of years.

## **LOCATION PLAN:**





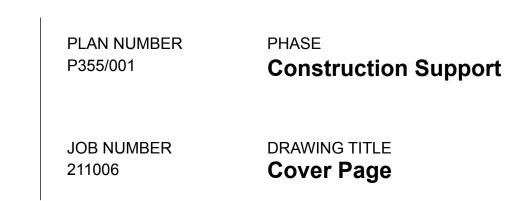

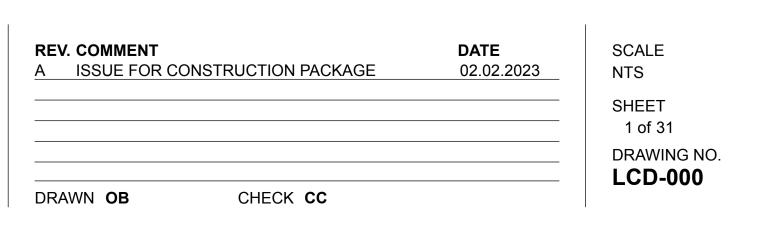



<sup>-</sup> Beware of underground services. Locations of underground services are indicative only. Their exact position should be proven on site. - Contractor to verify all dimensions on site before commencing work. - Report all discrepancies to Superintendent prior to construction.

<sup>-</sup> Figured dimensions to be taken in preference to scaled drawings. - All drawings may not be distributed without prior permission from the Landscape Architect.

#### **GENERAL REQUIREMENTS**

THE WORKS OF THIS TENDER SHALL COMPRISE THE SUPPLY OF ALL MATERIALS AND COMPLETION OF CONSTRUCTION AND ANCILLARY WORKS ASSOCIATED WITH THE PROJECT, AS SHOWN ON THE ACCOMPANYING DRAWINGS AND DESCRIBED WITHIN THE FOLLOWING PERFORMANCE NOTES.

#### **ROLES & RESPONSIBILITIES**

#### SUPERINTENDENT

THE SUPERINTENDENT PRIMARILY REFERS TO THE CONTRACTOR OR NOMINATED PROJECT MANAGER AS APPOINTED BY THE CLIENT.

#### **DRAWINGS**

ALL DIMENSIONS TO BE VERIFIED ON SITE PRIOR TO COMMENCEMENT OF WORK. DO NOT SCALE FROM DRAWINGS. THESE DRAWINGS ARE TO BE READ IN CONJUNCTION WITH DETAILS, MANUFACTURER'S SPECIFICATIONS & NOTES AND SUPPORTING DOCUMENTS, DRAWINGS AND SPECIFICATIONS. SEEK CLARIFICATION FROM THE SUPERINTENDENT IMMEDIATELY SHOULD ANY DISCREPANCIES BE FOUND BETWEEN DRAWINGS, DETAILS, SITE CONDITIONS OR MANUFACTURER'S SPECIFICATION.

#### **SUPPORTING REFERENCE DOCUMENTS & DRAWINGS**

LANDSCAPE DRAWINGS ARE TO BE READ IN CONJUNCTION WITH MATERIALS & FURNITURE SCHEDULE.

THE CONTRACTOR AND ALL TRADES MUST BE UNDERTAKE IN ACCORDANCE WITH THE AUSTRALIAN STANDARDS (AS) PERTAINING TO THOSE TRADES. ALL CONSTRUCTION TO COMPLY WITH THE NATIONAL CONSTRUCTION CODE (NCC), INCLUDING BUT NOT LIMITED TO:

- CONCRETE STRUCTURES (AS 3600)
- AGGREGATES AND ROCK FOR ENGINEERING PURPOSES, PART 1: CONCRETE AGGREGATES (AS 2758.1)
- SLAB & FOOTINGS (AS 2870)
- METHODS FOR SAMPLING AND TESTING AGGREGATES (AS 1141.33)
- DESIGN FOR ACCESS AND MOBILITY (AS 1428.1) (AS 1428.4.1) (AS 1428.2)) - METHODS FOR TESTING SOIL FOR ENGINEERING PURPOSES (AS 1289)
- SOILS FOR LANDSCAPING AND GARDEN USE (AS 4419)
- TREE STOCK FOR LANDSCAPE USE (AS 2303)
- PLAYGROUND EQUIPMENT AND SURFACING (AS 4685)
- PLAYGROUND SURFACING SPECIFICATION, REQUIREMENTS AND TEST METHOD (AS 4422)

#### OCCUPATIONAL HEALTH & SAFETY

THE CONTRACTOR IS TO SUBMIT TO THE SUPERINTENDENT CONFIRMATION OF OCCUPATIONAL HEALTH & SAFETY (OHS) MANAGEMENT AND THIRD PARTY ACCREDITATION IN ACCORDANCE WITH THE DEPARTMENTS REQUIREMENTS AND VICTORIAN CONSTRUCTION SUPPLIER REGISTER (CSR).

ALL HYDRAULIC / PLUMBING WORKS ARE TO BE PERFORMED BY A LICENSED / REGISTERED PLUMBER. APPLY FOR PERMITS AND PAY REQUIRED FEES AND CHARGES TO RESPONSIBLE AUTHORITIES. PROVIDE PERMITS AND CERTIFICATES TO THE SUPERINTENDENT ON COMPLETION OF WORKS.

FRANKSTON CITY COUNCIL HAS INSTALLED A NEW WATER METER IN CAGE WITH CONCRETE PAD SUITABLE FOR THE PROPOSED POTABLE WATER SERVICE. IT IS THE CONTRACTOR'S RESPONSIBILITY TO PROVIDE ALL UTILITIES/ DEVICES FROM THE METER, TO MEET THE OBLIGATIONS OF THE SPECIFICATION OR RELEVANT AUTHORITIES GUIDELINES/ STANDARDS

#### **ELECTRICAL//POWER SERVICES**

ALL ELECTRICAL WORKS TO BE PERFORMED BY A SUITABLY QUALIFIED AND LICENSED ELECTRICAL CONTRACTOR TO MEET AUSTRALIAN STANDARDS.

THE PROVISION OF POWER CONNECTION TO THE RESERVE WILL BE UNDERTAKEN BY FRANKSTON CITY COUNCIL PRIOR TO WORKS COMMENCING. IT IS THE CONTRACTOR'S RESPONSIBILITY TO PROVIDE ALL UTILITIES/ DEVICES FROM THE CONNECTION, TO MEET THE OBLIGATIONS OF THE SPECIFICATION OR RELEVANT AUTHORITIES GUIDELINES/STANDARDS.

#### DOCUMENTS REQUIRED PRIOR TO UNDERTAKING ANY WORKS

PRIOR TO UNDERTAKING ANY WORKS THE CONTRACTOR IS TO PROVIDE A TRAFFIC MANAGEMENT PLAN TO BE APPROVED BY COUNCIL. PERMITS WILL TAKE UP TO TEN BUSINESS DAYS FOR APPROVAL. AN APPROVED TRAFFIC MANAGEMENT PLAN MUST BE SUBMITTED TO THE CONTRACT SUPERINTENDENT PRIOR TO WORKS COMMENCING ON SITE. TRAFFIC AND PEDESTRIAN MANAGEMENT MUST BE COORDINATED WITH ALL SERVICE PROVIDERS WHO WILL REQUIRE ACCESS TO THE SITE AT DIFFERENT TIMES. NO VARIATION SHALL BE ALLOWED FOR A FAILURE TO DO SO.

PRIOR TO UNDERTAKING ANY WORKS THE CONTRACTOR IS TO PROVIDE TO THE SUPERINTENDENT, A SITE

- MANAGEMENT PLAN THAT INCLUDES BUT NOT LIMITED TO THE FOLLOWING: - PUBLIC SAFETY, AMENITY AND SITE SECURITY, INCLUDING LOCATIONS OF BARRIER FENCING AND SIGNAGE
- OPERATING HOURS - NOISE AND VIBRATION CONTROLS
- AIR AND DUST MANAGEMENT
- STORMWATER AND SEDIMENT CONTROL
- WASTE AND MATERIALS REUSE, INCLUDING AREAS FOR STORAGE OF MATERIALS AND PLANT
- TRAFFIC MANAGEMENT, INCLUDING VEHICLE PARKING - TEMPORARY SITE BUILDINGS
- SANITARY FACILITIES

ALL TEMPORARY BUILDINGS STRUCTURES SHALL BE MAINTAINED IN GOOD ORDER DURING CURRENCY OF THE CONTRACT AND SHALL BE REMOVED UPON COMPLETION. REFER TO ARCHITECT SPECIFICATION FOR FURTHER DETAIL.

CONTRACTOR TO COMPLY WITH WORKING HOURS STIPULATED IN THE LOCAL COUNCIL'S ORDINANCES AND EPA NOISE OMISSION GUIDELINES. ALL BUILDING WORKS ARE TO BE COMPLETED IN ACCORDANCE WITH THE BUILDING ACT 1993, BUILDING REGULATIONS 2006 AND RELEVANT BUILDING CODE INCLUDING NATIONAL CONSTRUCTION CODE (NCC).

#### PERMITS & FEES

THE CONTRACTOR IS TO ALLOW FOR ARRANGEMENT AND PAYMENT FOR ANY PERMITS AND / OR STATUTORY / AUTHORITY CHARGES REQUIRED TO COMPLETE THE WORKS.

#### **INSURANCES**

THE CONTRACTOR IS TO PROVIDE EVIDENCE OF ALL INSURANCES AT TIME OF SUBMITTING TENDER. ALL INSURANCES MUST BE CURRENT AND VALID FOR THE PERIOD OF THE WORKS PRIOR TO COMMENCING. INCLUDING PUBLIC LIABILITY, PROFESSIONAL INDEMNITY AND WORKERS COMPENSATION.

#### **MANUFACTURER SPECIFICATION & SHOP DRAWINGS**

CONTRACTOR TO PROVIDE SHOP DRAWINGS FOR ALL FURNITURE AND STRUCTURES TO BE REVIEWED, CONFIRMED AND APPROVED BY THE SUPERINTENDENT PRIOR TO ORDER AND MANUFACTURE.

ALL WORKS. SUPPLY AND INSTALLATION OF PROPRIETARY EQUIPMENT / FURNITURE INVOLVING MANUFACTURED ITEMS / MATERIALS ARE TO BE INSTALLED IN ACCORDANCE WITH THE MANUFACTURER SPECIFICATION, REQUIREMENTS, MOUNTING HEIGHTS, CIRCULATION ZONES ETC. AS TO NOT VOID WARRANTIES AND TO COMPLY WITH AUSTRALIAN STANDARDS WHERE REQUIRED AND OTHER APPLICABLE REGULATIONS.

THE CONTRACTOR SHALL PROVIDE SAMPLES OF MATERIALS AS SPECIFIED. NO MATERIAL SUBSTITUTIONS WILL BE MADE WITHOUT THE WRITTEN APPROVAL OF THE SUPERINTENDENT. SAMPLES ARE TO BE PROVIDED TO THE SUPERINTENDENT PRIOR TO BULK ORDERING AND DELIVERY TO THE SITE. THE CONTRACTOR IS RESPONSIBLE FOR ALL COSTS ASSOCIATED WITH THE INCORRECT ORDERING, PURCHASE OR REPLACEMENT OF INAPPROPRIATE MATERIALS.

- THE FOLLOWING MATERIALS AND SAMPLES MUST BE PROVIDED FOR APPROVAL:
- MINIMUM 1m x 1m SECTION OF INSITU CONCRETE PAVING (EACH TYPE)
- MINIMUM 1m x 1m SECTION OF COMPACTED LOCAL TOPPINGS - MINIMUM 500g SAMPLE OF CERTIFIED PLAYGROUND MULCH
- MINIMUM 500g SAMPLE OF RUBBER SOFTFALL GRANULE MIX
- MINIMUM 500g SAMPLE OF IMPORTED TOPSOIL
- MINIMUM 500g SAMPLE OF TIMBER GARDEN MULCH - MINIMUM 500g SAMPLE OF ROCK MULCH
- MINIMUM 500g SAMPLE OF LOCAL STONE (FOR MORTARED STONE AREA)
- SAMPLE OF PLEXIPAVE COLOUR(S)
- MINIMUM 1m x 1m SECTION OF COMPLETED RESEEDED GRASS
- SAMPLE OF STEEL EDGE PRODUCT
- MINIMUM 1 LINEAR METRE SECTION OF STEEL EDGE
- SAMPLE OF STEEL HOOP FOR GARDEN PROTECTION FENCE - ONE SAMPLE OF LOG STEPPER PREPARED
- ONE SAMPLE OF LOG SEAT PREPARED
- ONE SAMPLE OF BOULDER AS INSTALLED
- ONE SAMPLE OF BOULDER BENCH PREPARED AND INSTALLED
- ONE SAMPLE OF TIMBER WHEEL STOP

#### SITE CONDITIONS & PREPARATION (INCLUDING EARTHWORKS)

CONTRACTOR IS TO INFORM THEMSELVES OF ALL SITE CONDITIONS PRIOR TO TENDER SITE MEETING. ANY MATTERS THE CONTRACTOR DOES NOT DRAW TO ATTENTION PRIOR TO AWARDING THE CONTRACT AND WHICH MAY HAVE REASONABLY BEEN FORESEEN WILL NOT RELIEVE THE CONTRACTOR THE RESPONSIBILITY TO COMPLETE THE CONTRACT WITHOUT ADDITIONAL COST.

PRIOR TO COMMENCING WORKS, THE CONTRACTOR IS TO SUBMIT A DILAPIDATION REPORT TO THE SUPERINTENDENT. THE DILAPIDATION REPORT IS TO INCLUDE IMAGES AND A WRITTEN DESCRIPTION OF ALL ELEMENTS. ON COMPLETION OF THE WORKS, THE ENTIRE AREA OF THE WORKS AND ANY OTHER AREAS IMPACTED BY IT (INCLUDING OUTSIDE OF THE SITE) SHOULD BE THOROUGHLY CLEANED AND ALL TEMPORARY PROTECTION WORKS REMOVED.

CONTRACTOR TO ALLOW FOR ALL FILLING, GRADING AND TRIMMING, REMOVAL OF SPOIL, CLEANING, AND SURFACE PREPARATION FOR FINISHES AS SPECIFIED.

ALL AREAS TO BE LANDSCAPED SHALL BE FREE FROM WEEDS. PRIOR TO COMMENCING THE WORKS, THE CONTRACTOR IS TO SPRAY WORKS AREA WITH A COUNCIL APPROVED HERBICIDE SUCH AS BASTA (I.E. 'GLUFOSINATE AMMONIUM'). TREATED AREAS SHALL BE LEFT FOR A PERIOD OF UP TO TWENTY (20) DAYS. FOLLOWING HERBICIDE TREATMENT, REMOVE ALL VEGETATION WEED MATTER.

#### **EXISTING & UNDERGROUND SERVICES**

IT IS THE RESPONSIBILITY OF THE CONTRACTOR TO MAKE APPROPRIATE INVESTIGATIONS REGARDING THE EXACT LOCATION OF UNDERGROUND SERVICES PRIOR TO ANY CULTIVATION, RIPPING OR EXCAVATION. NO INFORMATION IS PROVIDED ON THE DRAWINGS REGARDING THE EXACT LOCATION OF EXISTING SERVICES. THE CONTRACTOR SHALL BE RESPONSIBLE FOR BEARING THE COST OF MAKING GOOD ANY DAMAGE TO EXISTING SERVICES AND MAINS, WHETHER OR NOT THESE ARE SHOWN ON THE DRAWINGS.

SUBMIT SERVICES DETECTION MAPPING AND A DIAL BEFORE YOU DIG (DBYD) TO SUPERINTENDENT. ALL GRADING AND EXCAVATION TO ALSO BE COMPLETED WITH REFERENCE TO DRAWINGS.

EXISTING SERVICES MAY BE USED AS A TEMPORARY SERVICE TO UNDERTAKE THE WORKS WITH THE APPROVAL OF THE SUPERINTENDENT. ALL CURRENT SERVICES ARE TO BE MAINTAINED AND MADE SAFE. IF THE SERVICES REQUIRE TEMPORARY DISCONNECTION THE CONTRACTOR IS TO RECONNECT AND MAKE GOOD

#### SECURITY, PROTECTION AND FENCING

CONTRACTOR TO ENSURE SEPARATE AND SECURE ACCESS TO THE EXTENT OF WORKS AREA FOR THE DURATION OF THE WORKS.

THE CONTRACTOR SHALL PROVIDE PROTECTION FENCING TO ALL NEWLY PLANTED AREAS FOR THE DURATION OF THE ESTABLISHMENT AND MAINTENANCE PERIOD OR AS INDICATED ON THE PLANS. FENCES SHOULD UTILISE CAPPED STAR PICKETS OF SUITABLE LENGTH FOR FENCE WITH HINGE JOINT MESH MINIMUM OF 6 STRAND X 90cm X 30cm. TWO STRAND SUPPORT WIRE FOR MESH WITH WHITE SIGHT WIRE FOR TOP STRAND, WHICH CAN BE USED TO HOLD CAPS IN PLACE. CORNER POSTS OF TREATED PINE SHOULD BE UTILISED TO STABILISE FENCES WITH DIAGONAL BRACING OR END ASSEMBLY ON CORNERS OR LONG RUNS AS REQUIRED. THESE FENCES SHOULD BE REMOVED ONCE PLANTING IS ESTABLISHED AT AROUND 12 MONTHS

#### PROTECTION OF EXISTING TREES

TREES SHALL BE PROTECTED IN ACCORDANCE WITH AUSTRALIAN STANDARD AS4970-2009. THE TREE PROTECTION FENCING IS TO BE PUT IN PLACE PRIOR TO THE COMMENCEMENT OF SITE WORKS AND REMAIN IN PLACE UNTIL ALL SITE WORKS HAVE BEEN COMPLETED. PRIOR TO THE COMMENCEMENT OF SITE WORKS, THE POSITIONING OF THE FENCE SHALL BE APPROVED BY THE SUPERINTENDENT. PROTECTIVE FENCING IS TO BE LABELLED 'TREE PROTECTION ZONE'.

MECHANICAL EXCAVATION IS ONLY ALLOWED OUTSIDE OF TPZ'S. UNLESS OTHERWISE SPECIFIED, NO WORKS SHALL BE CARRIED OUT WITHIN THE TPZ. WHEN EXCAVATION IS REQUIRED WITHIN TPZ OF TREES TO BE RETAINED, USE HAND EXCAVATION TO LOCATE ANY ROOTS. TREE ROOTS EXCEEDING 30mm DIAMETER ARE SIGNIFICANT TREE ROOTS. WHERE IT IS NECESSARY TO CUT TREE ROOTS, CLEAN CUT USING SHARP HAND TOOLS. WHERE POSSIBLE ROOTS ARE TO BE CUT ON A 90° ANGLE MINIMISING THE SIZE OF THE AREA CUT. SEAL TREE ROOT CUTS WITH 'SERIPUNE' OR AN APPROVED EQUIVALENT TREE WOUND SEALANT. ALL ROOT PRUNING SHOULD BE UNDERTAKEN BY A QUALIFIED ARBORIST.

NO DIG ZONE APPROACH WITHIN TPZs OF TREES. NOMINAL 50MM DEPTH EXISTING GRASS AND THATCH LAYER TO BE REMOVED PRIOR TO PREPARATION OF EXISTING SUBGRADE. MINIMAL DISTURBANCE WITHIN NO DIG ZONE. WORKS WITHIN AREA TO BE UNDERTAKEN WITH SUPERVISION OF SUITABLY QUALIFIED ARBORIST OR AS OTHERWISE INSTRUCTED BY SUPERINTENDENT.

ENSURE GRADING AND TRIMMING OF THE SUBGRADE LEVEL ALLOWS FOR THE SPECIFIED HEIGHTS OF THE SUBBASE AND FINISHING COURSE IN ACCORDANCE WITH LANDSCAPE DETAILS AND DRAWINGS. FINISH OFF EXCAVATED AREAS WITH AN EVEN CONSISTENT SURFACE AND FILL DEPRESSIONS WITH SOUND MATERIAL.

USE MATERIAL EXCAVATED DURING THE TRIMMING AS GRADING WORKS AS FILL OR BASE MATERIAL IF DEEMED APPROPRIATE BY SUPERINTENDENT, REMOVE EXCESS EXCAVATED MATERIAL OFF SITE. ALL GRADING TO PITS AND OTHER DRAINAGE STRUCTURES OR NATURAL DRAINAGE PATHS SHALL BE SMOOTH AND GRADUAL

LIMIT WORK ZONES TO MINIMISE DISTURBANCE TO ADJACENT SURFACES AND DRAINAGE AREAS. ENSURE ANY CONSTRUCTION MATERIAL AND DEBRIS ARE DISPOSED OFF SITE APPROPRIATELY AND NOT WASHED INTO

DURING THE CONTRACT PERIOD, PRIOR TO THE ISSUE OF PRACTICAL COMPLETION, THE CONTRACTOR SHALL BE LIABLE TO RECTIFY / REPLACE MALICIOUS AND UNLAWFUL DAMAGE INSTRUCTED BY AND TO THE SATISFACTION OF THE SUPERINTENDENT. THE CONTRACTOR SHALL BE LIABLE FOR THE COSTS OF RECTIFICATION OR AS AGREED WITH THE SUPERINTENDENT. ANY DAMAGE TO EXISTING STRUCTURE, SERVICES, AND FINISHES OCCURRING / DURING THE WORKS MUST BE MADE GOOD. ANY DAMAGE TO COMPLETED WORK MUST BE MADE

#### **DEFECTS LIABILITY PERIOD & ESTABLISHMENT PERIOD**

THE WHOLE OF THE WORKS SHALL BE UPHELD AGAINST ANY DEFECTS DUE TO FAULTY AND / OR INFERIOR QUALITY MATERIALS AND / OR WORKMANSHIP FOR A PERIOD OF 12 MONTHS. AS PER CONDITIONS OUTLINED AND AS REQUIRED BY COUNCIL.

ESTABLISHMENT INCLUDES THE CARE OF THE CONTRACT AREAS BY ACCEPTED HORTICULTURAL PRACTICES, INCLUDING RECTIFYING ANY DEFECTS THAT BECOME APPARENT IN THE WORKS UNDER NORMAL USE. THIS SHALL INCLUDE, BUT SHALL NOT BE LIMITED TO, THE FOLLOWING ITEMS WHERE AND AS REQUIRED: - WATERING, FERTILISING, CULTIVATION, TOP DRESSING, RENOVATING, AERATING, WEEDING, PESTS AND DISEASE CONTROL, STAKING, REPLACEMENT OF PLANT MATERIALS, REPLANTING, PRUNING, KEEPING THE SITE NEAT AND

- MAKE GOOD SOIL SUBSIDENCE.

TIDY.

- ENSURE MULCHED SURFACES ARE KEPT IN A CLEAN AND TIDY CONDITION AND REINSTATE AND MAKE TIDY IF DISTURBED DURING WORKS PERIOD.

#### SITE DRAINAGE - REFER LCD-300 SERIES, LCD-900

ALL STORMWATER WORKS, MATERIALS, PIT SIZE AND DEPTHS TO BE IN ACCORDANCE WITH AS 3500.3. ALL INFORMATION TO BE CONFIRMED ONSITE WITH SOIL INFILTRATION RATE AND IN ACCORDANCE WITH AUSTRALIAN

CONNECTION TO EXISTING STORMWATER SYSTEM / LEGAL POINT OF DISCHARGE, TO BE CONFIRMED ONSITE WITH SUPERINTENDENT PRIOR TO COMMENCING WORKS. DRAWINGS SHOW INDICATIVE DRAINAGE DESIGN ONLY.

SUPPLY AND INSTALL 100mm DIAMETER SLOTTED AGRICULTURAL PIPE WITH FILTER SOCK IN GRAVEL TRENCH WITH A MINIMUM 50mm BED FOR THE PIPE IN LOCATIONS AS SHOWN. ENSURE DRAINAGE MEETS AUSTRALIAN STANDARDS AND EFFECTIVE DRAINAGE WILL BE ACHIEVED TO OUTLET AREAS AS SHOWN.

UNLESS NOTED OTHERWISE, ALL 100mm DIAMETER AGRICULTURAL DRAINAGE TO GRADE 1:100 MINIMUM AS PER AUSTRALIAN STANDARDS. CONFIRM WITH SUPERINTENDENT. PROVIDE INSPECTION OPENING (IO) AT ALL UPSTREAM END OF PIPE, TO BE CONFIRMED WITH SUPERINTENDENT.

SUPPLY AND INSTALL 100mm DIAMETER uPVC PIPE IN TRENCHES AT RIGHT ANGLE UNDER PATHS IN CONDUIT AND AS SHOWN. ENSURE DRAINAGE MEETS AUSTRALIAN STANDARDS AND EFFECTIVE DRAINAGE WILL BE ACHIEVED TO OUTLET AREAS AS SHOWN.

UNLESS NOTED OTHERWISE, 100mm DIAMETER PIPES TO GRADE 1:100 MINIMUM AS PER AUSTRALIAN STANDARDS. CONFIRM WITH SUPERINTENDENT.

#### **DRAINAGE PIT**

ACCORDANCE WITH DRAWINGS.

DRAINAGE PIT - TYPE 1 (GP1). SUPPLY AND INSTALL STORMWATER PIT UNDER TIMBER PLAYGROUND MULCH, 460mm(L) X 460mm(W) RELN SERIES 410 STORMWATER PIT WITH CLASS B GRATED PIT LID, OR EQUIVALENT APPROVED BY SUPERINTENDENT, IN

DRAINAGE PIT - TYPE 2 (GP2). SUPPLY AND INSTALL MODIFIED GRATED PIT LID TO EXISTING JUNCTION PIT TO AUSTRALIAN STANDARDS. (CONFIRM WITH SUPERINTENDENT AND WATER AUTHORITY (MELBOURNE WATER).

## SUMP PIT

SUMP PIT (SP) UNDER GRASS AREA TO BE 900L CAPACITY. LOCATION OF SUMP PIT TO BE CONFIRMED WITH SUPERINTENDENT ONSITE. TO CONFORM TO ALL RELEVANT AUSTRALIAN STANDARDS.

## SURFACES - REFER LCD-500 SERIES, LCD-900, LCD-901

#### SURFACE TYPE 1 (SF01) CONCRETE PAVING, TYPE 1 (PEDESTRIAN GRADE)

CONCRETE PAVING TO BE IN ACCORDANCE WITH DRAWINGS. CONCRETE PAVING TO BE 'MOONSCAPE' COLOUR OR APPROVED EQUIVALENT. REINFORCING MESH IN ACCORDANCE WITH DOCUMENTATION OR COUNCIL STANDARD DETAIL. APPLY A BROOM FINISH TO CONCRETE AREAS AS SHOWN. FINISHED SURFACE TO BE SMOOTH AND EVEN, AND CONFORM TO ALL RELEVANT AUSTRALIAN STANDARDS INCLUDING: AS 3600, AS 4586 AND AS 1379.

SUPPLIER: HANSON (OR APPROVED EQUIVALENT)

#### SURFACE TYPE 2 (SF02) CONCRETE PAVING, TYPE 2 (PEDESTRIAN GRADE)

CONCRETE PAVING TO BE IN ACCORDANCE WITH DRAWINGS. CONCRETE PAVING TO BE 'RIVERLBLEND BEIGE' COLOUR OR APPROVED EQUIVALENT. REINFORCING MESH IN ACCORDANCE WITH DOCUMENTATION OR COUNCIL STANDARD DETAIL. APPLY A FLOAT FINISH WITH ROCK SALT TO CONCRETE AREAS AS SHOWN. FINISHED SURFACE TO BE SMOOTH AND EVEN, AND CONFORM TO ALL RELEVANT AUSTRALIAN STANDARDS INCLUDING: AS 3600, AS 4586 AND AS 1379.

SUPPLIER: ALLCON (OR APPROVED EQUIVALENT)

PLAN NUMBER

#### MULTI-COURT SURFACE - PLEXIPAVE

SUPPLY AND INSTALL NUTECH "NUCOURT" COLOURED ACRYLIC SPORT SURFACE COATING ON CONCRETE PAVING IN AREAS AS SHOWN. LINE MARKING COLOUR IS TO BE "WHITE". COLOURS TO BE CONFIRMED WITH SUPERINTENDENT PRIOR TO ORDERING.

ALL LINEMARKING, DIMENSIONS AND LAYOUT OF EQUIPMENT TO BE CONFIRMED WITH SUPERINTENDENT PRIOR TO INSTALLATION.

#### SURFACE TYPE 3 (SF03) - LOCAL TOPPINGS (VEHICULAR GRADE TO PARKING BAY AREAS)

FINISHING COURSE OF MINIMUM 50mm COMPACTED DEPTH FINE GRAINED, YELLOW/BROWN, GRANITIC GRAVEL/SAND OF LOW PLASTICITY WITH A PH RANGE OF 4-7, AND A MAXIMUM SILT CONTENT OF 6% (BY VOLUME) AS ACCORDANCE WITH AS 1141.33. MATERIAL AS SPECIFIED OR EQUIVALENT APPROVED BY SUPERINTENDENT.

MIXED WITH A NON TOXIC ORGANIC SOIL ADDITIVE TO BIND AND CREATE A HARD-WEARING SURFACE. THE BINDING AGENT SHALL BE A COLOURLESS, ODOURLESS POWDER SUCH AS STALOK™ OR A SIMILAR APPROVED MATERIAL. THE BINDING AGENT SHALL BE MIXED WITH THE GRANITIC GRAVEL IN A MECHANICAL DRUM MIXER TO ENSURE AN EVEN CONTENT THROUGH THE ENTIRE MIX. THE BINDING AGENT TO BE APPLIED AT A RATIO OF 2% TO THE DRY WEIGHT OF THE GRAVEL BEING APPLIED AS PER MANUFACTURER SPECIFICATION. THE BONDING AGENT SHALL BE MIXED BY MECHANICAL MEANS INTO THE GRAVEL PRIOR TO PLACEMENT AND COMPACTION.

EACH LAYER TO BE WATERED IN AND COMPACTED PROGRESSIVELY. THE FINISHED SURFACE SHALL BE CROWNED, FREE DRAINING, NOT LIABLE TO PONDING EITHER ON OR AT PATH EDGES, FLUSH WITH ALL ADJOINING EDGES AND WELL COMPACTED TO AUSTRALIAN STANDARDS.

WORK WITHIN NO DIG ZONE TO INCLUDE A SUBBASE OF NO FINES CONCRETE AS DETAILED AND IN ACCORDANCE WITH RELEVANT AUSTRALIAN STANDARDS AND CCA INDUSTRY REQUIREMENTS, INCLUDING AS 2758.1, OR AS OTHERWISE INSTRUCTED BY THE SUPERINTENDENT. ENSURE ARBORIST IS ONSITE TO REVIEW AND PROVIDE GUIDANCE FOR WORKS WITHIN TREE PROTECTION ZONES.

#### SURFACE TYPE 4 (SF04) - RUBBER SOFTFALL

SUPPLY AND INSTALL RUBBER TOUGH INDUSTRIES GEZOLAN EPDM RUBBER WETPOUR IN '50% LAVENDER, 30% ARCTIC AND 20% ASH' WITH SUBBASE AS DETAILED AND TO MANUFACTURER SPECIFICATION. DEPTH OF RUBBER IMPACT LAYER VARIES. INSTALL WITH DEPTH SUFFICIENT TO EXCEED THE FALL HEIGHT OF PLAY EQUIPMENT PLUS MINIMUM 10% TO COMPLY WITH AUSTRALIAN STANDARDS. IMPACT ATTENUATION TESTING TO BE COMPLETED BY AN INDEPENDENT PLAYGROUND AUDITOR AT COMPLETION OF INSTALLATION TO ENSURE COMPLIANCE WITH TEST REQUIREMENTS OF AS4422.

IMPACT ATTENUATION TESTING TO BE COMPLETED BY AN INDEPENDENT PLAYGROUND AUDITOR AT COMPLETION OF INSTALLATION TO ENSURE COMPLIANCE WITH TEST REQUIREMENTS OF AS4422.

SUPPLIER: RUBBER TOUGH INDUSTRIES (OR APPROVED EQUIVALENT)

#### SURFACE TYPE 5 (SF05) - CERTIFIED PLAYGROUND MULCH

SUPPLY AND SPREAD CERTIFIED TIMBER PLAYGROUND MULCH AT THE NOMINATED COMPACTED DEPTH OF 300mm TO PLAY AREAS AS SHOWN ON THE DRAWINGS. TIMBER PLAYGROUND MULCH TO BE 100% PINE, A CERTIFIED PRODUCT FOR PLAYGROUNDS AND MUST COMPLY WITH AUSTRALIAN STANDARD AS4685.0; RATED FAIR TO EXCELLENT, MAJORITY COMPOSED OF EVEN SIZED CHIPS OF PINE, MOSTLY FREE FROM SHARP OR POINTED PARTICLES. PRODUCT TO BE 'CERTIFIED PLAYGROUND SOFTFALL' TO PLAYGROUND CERTIFICATION STANDARDS, AS COMPLIANT AND APPROVED.

SPREAD AND ROLL MULCH SO THAT AFTER SETTLING, OR AFTER ROLLING, IT IS:

- SMOOTH AND EVENLY GRADED BETWEEN DESIGN SURFACE LEVELS; - FLUSH WITH ADJACENT FINISHED LEVELS; AND

- OF THE REQUIRED DEPTHS TO COMPLY WITH AUSTRALIAN STANDARDS.

CONTRACTOR TO ENGAGE INDEPENDENT PLAYGROUND AUDITOR TO UNDERTAKE IMPACT ATTENUATION TESTING AT COMPLETION OF INSTALLATION TO ENSURE COMPLIANCE WITH TEST REQUIREMENTS OF AS4422.

SURFACE TYPE 6 (SF06) & TYPE 7 (SF07) - TIMBER GARDEN MULCH AND TIMBER GARDEN MULCH (TOP UP) REFER TO SOFT LANDSCAPE SECTION FOR PREPARATION WORKS.

SUPPLY AND SPREAD 75mm DEPTH OF APPROVED RECYCLED TIMBER MULCH TO ALL PLANTING AREAS AS SHOWN. USE OF SALVAGED PLAYGROUND MULCH TO BE CONFIRMED WITH SUPERINTENDENT. TRIM AND GRADE AND ENSURE THAT MULCH TAPERS TO BASE OF TREES AND PLANTS.

REFER TO SOFT LANDSCAPE SECTION FOR PREPARATION WORKS.

SUPPLY AND SPREAD COUNCIL APPROVED. DROUGHT TOLERANT KIKUYU SEED MIX TO MAKE GOOD OF DISTURBED SURFACES UPON OF COMPLETION OF WORKS. SUPERINTENDENT TO APPROVE SUPPLY PRIOR TO ORDER AND DELIVERY TO SITE.

#### SURFACE TYPE 8 (SF08) - ROCK MULCH

SUPPLY AND SPREAD 50mm DEPTH OF APPROVED BLUESTONE SCREENINGS Ø10MM-Ø20MM, NO FINES OR EQUIVALENT APPROVED BY SUPERINTENDENT. TRIM, GRADE AND ENSURE THAT MULCH TAPERS TO BASE OF TREES AND PLANTING. INSTALLED WITHIN PLANTING AREA AS SHOWN.

#### SURFACE TYPE 9 (SF09) - TEXTURED STONE SURFACE

SKILLION ROOF OF SHELTER TO ALLOW FOR RUNOFF ONTO TEXTURED STONE SURFACE AND GARDEN BED BELOW. INSITU MORTARED BLUESTONE ROUGH STONE SCOUR AREA INSTALLED WITH FALL TOWARDS GARDEN BED. MATCH COLOUR OF MORTAR TO STONE COLOUR.

#### SOFT LANDSCAPE - REFER LCD-500 SERIES, LCD-700 SERIES, LCD-900 SERIES REFER TO PROTECTION OF EXISTING TREE SECTION FOR WORKS WITHIN TREE PROTECTION ZONES.

#### LOW PLANTING & LAWN AREAS PREPARATION

APPLY HERBICIDE TO LANDSCAPE AREAS AS PER PRODUCT SPECIFICATION PRIOR TO PLANTING WORKS TO REMOVE ALL EXISTING VEGETATION. USE OF COUNCIL APPROVED HERBICIDE SUCH AS BASTA (I.E.'GLUFOSINATE AMMONIUM') OR ALTERNATIVE TO BE CONFIRMED BY SUPERINTENDENT. FOLLOWING HERBICIDE TREATMENT, REMOVE ALL VEGETATION WEED MATTER.

THIS PREPARATION IS TO INCLUDE THE REMOVAL OF MATERIAL AND CULTIVATION TO ENSURE THAT THE PLANTING AREA IS FREE DRAINING AND NOT COMPACTED. ROCKS, RUBBLE AND OTHER MATERIAL LARGER THAN 50mm, SHALL BE REMOVED FROM THE PLANTING AREA AND FROM EXCAVATED SITE SOIL PRIOR TO INCORPORATING WITH IMPORTED TOPSOIL. A ROTARY HOE MAY NOT BE USED WITHIN THE TREE PROTECTION ZONE OF EXISTING TREES.

MUST BE CURRENT FOR THE TOPSOIL BEING SUPPLIED. TEST RESULTS MUST BE DATED. APPROVED TOPSOIL SHALL BE FREE OF CLODS, STONES AND ALL OTHER EXTRANEOUS MATTER GREATER THAN 20mm DIAMETER. LOW PLANTING AREAS ARE TO BE CULTIVATED TO A MINIMUM DEPTH OF 200mm, LIGHTLY ROLLED. THE APPLICATION OF LAYERS SHOULD NOT EXCEED 150mm. ENSURE APPROVED IMPORTED TOPSOIL ACHIEVES A

PROVIDE A LOCALLY SOURCED TOPSOIL SAMPLE COMPLETE WITH THE SUPPLIER'S CURRENT SOIL TESTING

DETAILS FOR APPROVAL BY THE SUPERINTENDENT PRIOR TO ORDERING AND SUPPLY. NOTE: ALL SOIL TESTING

GRASS AREAS ARE TO BE CULTIVATED TO A MINIMUM DEPTH OF 100mm, LIGHTLY ROLLED, CONSISTING OF MIXED 50% APPROVED IMPORTED TOPSOIL / 50% SITE SOIL OR MADE GOOD WHERE APPLICABLE. TRIM AND GRADE

FINE, EVEN SURFACE FINISH WITH ADEQUATE DRAINAGE. TRIM AND GRADE AREAS AFTER BACKFILL

THE TOPSOIL SURFACE SHALL BE INSPECTED BY THE SUPERINTENDENT PRIOR TO MULCHING AND RESEEDING.

POLLEN

- Contractor to verify all dimensions on site before commencing work. - Report all discrepancies to Superintendent prior to construction.

YARRALUMLA RESERVE Capital Works

Frankston City Council 30 Davey Street, Frankston VIC 3199 P355/001 **Construction Support** JOB NUMBER DRAWING TITLE 211006 **Performance Notes** 

DATE **REV. COMMENT** A ISSUE FOR CONSTRUCTION PACKAGE 02.02.2023 DRAWN **OB** CHECK CC

AREAS AFTER BACKFILL APPLICATION.

SHEET 2 of 31 DRAWING NO. LCD-100

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Landscape Architect.

- Beware of underground services. Locations of underground services are indicative only. Their exact position should be proven on site.

- Figured dimensions to be taken in preference to scaled drawings. - All drawings may not be distributed without prior permission from the

FOR CONSTRUCTION

PLANTING COUNTS ON PLANS TAKE PRECEDENCE OVER NUMBERS ON SCHEDULE

SUPPLY AND INSTALL PLANTING AS SHOWN. SET OUT OF PLANTING TO BE CONFIRMED AND APPROVED BY SUPERINTENDENT PRIOR TO INSTALLATION. REFER DRAWINGS AND PLANT SCHEDULE. TICKLE THE ROOT BALL OF EACH PLANT IN ORDER TO FREE ROOTS FROM POTTING MIXTURES. ENSURE OVER EXCAVATE PLANTING HOLES SLIGHTLY LARGER THAN ROOTBALL AS DETAILED. WATER IMMEDIATELY AFTER PLANTING WITH AT LEAST 4 LITRES OF WATER TO CONSOLIDATE THE BACKFILL AROUND ROOTS.

PLANTING COUNTS ON PLANS TAKE PRECEDENCE OVER NUMBERS ON SCHEDULE.

TREE SUPPLY TO BE APPROVED BY SUPERINTENDENT. TREES TO BE HEALTHY, WELL-GROWN SPECIMENS FREE OF PESTS AND DISEASE WITH ACCEPTABLE ROOT TO SHOOT RATIO.

SUPPLY AND INSTALL TREES AS SHOWN IN ACCORDANCE WITH ARBORIST ADVICE OR SUPPLIER PREFERRED PLANTING APPROACH AND AFTER CARE RECOMMENDATIONS. SET OUT OF PLANTING TO BE CONFIRMED AND APPROVED BY SUPERINTENDENT PRIOR TO INSTALLATION. REFER DRAWINGS AND PLANT SCHEDULE. TICKLE THE ROOT BALL OF EACH PLANT IN ORDER TO FREE ROOTS FROM POTTING MIXTURES. CARE TO BE TAKEN TO NOT EXPOSE THE ROOT BALL TO DRYING INFLUENCES. ENSURE OVER EXCAVATE PLANTING HOLES SLIGHTLY LARGER THAN ROOTBALL AS DETAILED. FORM A TOPSOIL RING BERM AS A WATER SAUCER FOR THE TREE AS DETAILED. WATER IMMEDIATELY AFTER PLANTING WITH AT LEAST 45 LITRES OF WATER TO CONSOLIDATE THE BACKFILL AROUND ROOTS OR AS OTHERWISE DIRECTED BY ARBORIST OR SUPPLIER. TREE PLANTING WILL REQUIRE MAINTENANCE FOR ESTABLISHMENT IN ACCORDANCE WITH CONTRACT REQUIREMENTS.

INSTALL TREE COACH SYSTEM TO ALL TREE PLANTING IN ACCORDANCE WITH DRAWINGS AND MANUFACTURER'S SPECIFICATION.

#### EDGING - REFER LCD-500, LCD-901

#### STEEL EDGE (ST)

SUPPLY AND INSTALL APPROVED STEEL EDGE SECURED TO STAKES AS DETAILED. FINISH FLUSH TO ADJACENT SURFACE MATERIAL. ENSURE STAKES ARE UNDER THE LEVEL OF SOIL IF REQUIRED ON FACE. REFER TO MANUFACTURER'S SPECIFICATION FOR INSTALLATION INSTRUCTIONS.

SUPERINTENDENT TO APPROVE STEEL EDGE SAMPLE AND SUPPLY PRIOR TO ORDER AND DELIVERY TO SITE.

FORM A CONSISTENT SPADE CUT MULCH EDGE BETWEEN PLANTING AREAS AND GRASS AREAS AS SHOWN AND

#### PLAY EQUIPMENT - REFER LCD-600 SERIES

REFER TO FURNITURE AND PLAY EQUIPMENT SCHEDULE FOR SPECIFIED SUPPLIER, CODE AND DESCRIPTION. ALTERNATIVE EQUIVALENT SUPPLIERS TO BE CONFIRMED BY COUNCIL.

CONTRACTOR TO ENGAGE INDEPENDENT PLAYGROUND AUDITOR TO UNDERTAKE A POST-CONSTRUCTION PLAYGROUND INSPECTION TO ENSURE COMPLIANCE WITH AUSTRALIAN STANDARDS.

#### PLAY EQUIPMENT TYPE 1 (P01) - SENIOR PLAY UNIT

SUPPLY AND INSTALL APPROVED PLAY EQUIPMENT AS SHOWN TO MANUFACTURER'S SPECIFICATION. CONTRACTOR TO CONFIRM COLOUR SELECTION WITH SUPPLIER AND PROVIDE SUPERINTENDENT WITH FINAL SHOP DRAWINGS OF PLAY UNIT FOR APPROVAL PRIOR TO ORDER.

#### PLAY EQUIPMENT TYPE 2 (P02) - JUNIOR PLAY UNIT

SUPPLY AND INSTALL APPROVED PLAY EQUIPMENT AS SHOWN TO MANUFACTURER'S SPECIFICATION. CONTRACTOR TO CONFIRM COLOUR SELECTION WITH SUPPLIER AND PROVIDE SUPERINTENDENT WITH FINAL SHOP DRAWINGS OF PLAY UNIT FOR APPROVAL PRIOR TO ORDER

#### PLAY EQUIPMENT TYPE 3 (P03) - TRIPLE SWINGS

SUPPLY AND INSTALL APPROVED PLAY EQUIPMENT AS SHOWN TO MANUFACTURER'S SPECIFICATION. CONTRACTOR TO CONFIRM COLOUR SELECTION WITH SUPPLIER AND PROVIDE SUPERINTENDENT WITH FINAL SHOP DRAWINGS INCLUDING CONFIRMED COLOUR SELECTION FOR APPROVAL PRIOR TO ORDER.

#### PLAY EQUIPMENT TYPE 4 (P04) - BASKET SWING

SUPPLY AND INSTALL APPROVED PLAY EQUIPMENT AS SHOWN TO MANUFACTURER'S SPECIFICATION CONTRACTOR TO CONFIRM COLOUR SELECTION WITH SUPPLIER AND PROVIDE SUPERINTENDENT WITH FINAL SHOP DRAWINGS INCLUDING CONFIRMED COLOUR SELECTION FOR APPROVAL PRIOR TO ORDER.

#### PLAY EQUIPMENT TYPE 5 (P05) - FLYING SAUCER

SUPPLY AND INSTALL APPROVED PLAY EQUIPMENT AS SHOWN TO MANUFACTURER'S SPECIFICATION. CONTRACTOR TO CONFIRM COLOUR SELECTION WITH SUPPLIER AND PROVIDE SUPERINTENDENT WITH FINAL SHOP DRAWINGS INCLUDING CONFIRMED COLOUR SELECTION FOR APPROVAL PRIOR TO ORDER.

#### **FURNITURE - REFER LCD-600 SERIES**

REFER TO FURNITURE AND PLAY EQUIPMENT SCHEDULE FOR SPECIFIED SUPPLIER, CODE AND DESCRIPTION. ALTERNATIVE EQUIVALENT SUPPLIERS TO BE CONFIRMED BY COUNCIL.

ALL TIMBER TO BE WEATHER TREATED WITH A COUNCIL APPROVED PRODUCT.

ENSURE INSTALLATION OF FURNITURE ALLOWS FOR A CLEAR ENVELOPE FOR REQUIRED CLEARANCE TO OTHER ELEMENTS, ALLOWS FOR ACCESSIBLE USE (AS REQUIRED) AND PEDESTRIAN MOVEMENT. SETOUT TO BE CONFIRMED ON-SITE BY SUPERINTENDENT PRIOR TO INSTALLATION.

#### FURNITURE TYPE 1 (FN01) - PICNIC SHELTER

SUPPLY AND INSTALL FURNITURE AS SPECIFIED. TO BE INSTALLED AS BOLT DOWN FIXING ONTO CONCRETE PAVING TO MANUFACTURER'S SPECIFICATION AND AS CONFIRMED BY SUPERINTENDENT.

FINAL DESIGN AND DETAIL SUBJECT TO SHOP DRAWINGS AND SPECIFICATION BY SUPPLIER, SUBMITTED AND APPROVED BY SUPERINTENDENT PRIOR TO FABRICATION.

#### FURNITURE TYPE 2 (FN02a) - PICNIC SETTING - TYPE 1

SUPPLY AND INSTALL FURNITURE AS SPECIFIED. TO BE INSTALLED AS BOLT DOWN FIXING ONTO CONCRETE PAVING TO MANUFACTURER'S SPECIFICATION AND AS CONFIRMED BY SUPERINTENDENT. ENSURE FURNITURE MAINTAINS DDA COMPLIANT DESIGN ONCE INSTALLED.

FINAL DESIGN AND DETAIL SUBJECT TO SHOP DRAWINGS AND SPECIFICATION BY SUPPLIER, SUBMITTED AND APPROVED BY SUPERINTENDENT PRIOR TO FABRICATION.

#### FURNITURE TYPE 2 (FN02b) - PICNIC SETTING - TYPE 2

SUPPLY AND INSTALL FURNITURE AS SPECIFIED. TO BE INSTALLED AS BOLT DOWN FIXING ONTO CONCRETE PAVING TO MANUFACTURER'S SPECIFICATION AND AS CONFIRMED BY SUPERINTENDENT.

FINAL DESIGN AND DETAIL SUBJECT TO SHOP DRAWINGS AND SPECIFICATION BY SUPPLIER, SUBMITTED AND APPROVED BY SUPERINTENDENT PRIOR TO FABRICATION.

#### FURNITURE TYPE 3 (FN03) - BBQ SETTING

SUPPLY AND INSTALL FURNITURE AS SPECIFIED. TO BE INSTALLED AS BOLT DOWN FIXING ONTO CONCRETE PAVING TO MANUFACTURER'S SPECIFICATION AND AS CONFIRMED BY SUPERINTENDENT.

FINAL DESIGN AND DETAIL SUBJECT TO SHOP DRAWINGS AND SPECIFICATION BY SUPPLIER, SUBMITTED AND APPROVED BY SUPERINTENDENT PRIOR TO FABRICATION. ELECTRICAL AND WATER CONNECTION TO BE CONFIRMED ONSITE WITH SUPERINTENDENT.

SUPPLIER TO INTEGRATE BIB TAP UNDERNEATH BARBEQUE UNIT. FABRICATION WITH PROVISION OF UPSTAND. CONFIRMATION AND APPROVAL BY SUPERINTENDENT. MODIFICATIONS TO MAINTAIN DDA COMPLIANCE.

#### FURNITURE TYPE 4 (FN04) - SEAT WITH BACK

SUPPLY AND INSTALL FURNITURE AS SPECIFIED. TO BE INSTALLED AS BOLT DOWN FIXING ONTO CONCRETE PAVING TO MANUFACTURER'S SPECIFICATION AND AS CONFIRMED BY SUPERINTENDENT.

FINAL DESIGN AND DETAIL SUBJECT TO SHOP DRAWINGS AND SPECIFICATION BY SUPPLIER, SUBMITTED AND APPROVED BY SUPERINTENDENT PRIOR TO FABRICATION.

#### FURNITURE TYPE 5 (FN05) - PLATFORM SEAT

SUPPLY AND INSTALL FURNITURE AS SPECIFIED. TO BE INSTALLED AS BOLT DOWN FIXING ONTO CONCRETE PAVING TO MANUFACTURER'S SPECIFICATION AND AS CONFIRMED BY SUPERINTENDENT.

FINAL DESIGN AND DETAIL SUBJECT TO SHOP DRAWINGS AND SPECIFICATION BY SUPPLIER, SUBMITTED AND APPROVED BY SUPERINTENDENT PRIOR TO FABRICATION.

#### FURNITURE TYPE 6 (FN06) - BIN ENCLOSURE

SUPPLY AND INSTALL FURNITURE AS SPECIFIED. TO BE INSTALLED AS BOLT DOWN FIXING ONTO CONCRETE PAVING TO MANUFACTURER'S SPECIFICATION AND AS CONFIRMED BY SUPERINTENDENT.

FINAL DESIGN AND DETAIL SUBJECT TO SHOP DRAWINGS AND SPECIFICATION BY SUPPLIER, SUBMITTED AND APPROVED BY SUPERINTENDENT PRIOR TO FABRICATION.

#### FURNITURE TYPE 7 (FN07) - DRINKING FOUNTAIN

SUPPLY AND INSTALL FURNITURE AS SPECIFIED. DRINKING FOUNTAIN TO BE INSTALLED IN ACCORDANCE WITH MANUFACTURER'S SPECIFICATION AND CERTIFIED BY A LICENSED PLUMBER. SURFACE RUNOFF GRADED TO ADJACENT GARDEN BED, OR AS CONFIRMED BY SUPERINTENDENT.

DRINKING FOUNTAIN CONNECTION TO WATER LINE TO BE CONFIRMED ONSITE WITH SUPERINTENDENT.

FINAL DESIGN AND DETAIL SUBJECT TO SHOP DRAWINGS AND SPECIFICATION BY SUPPLIER, SUBMITTED AND APPROVED BY SUPERINTENDENT PRIOR TO FABRICATION.

#### FURNITURE TYPE 8 (FN08) & TYPE 9 (FN09) NETBALL & BASKETBALL HOOPS

SUPPLY AND INSTALL NETBALL AND BASKETBALL POST AND HOOPS, AND BASKETBALL BACKBOARD AS SPECIFIED TO MANUFACTURER'S SPECIFICATION. ALL FOOTING REQUIREMENTS ARE SUBJECT TO GEOTECHNICAL REPORT AND STRUCTURAL ENGINEER RECOMMENDATIONS.

#### TIMBER WHEEL STOPS

WHEEL STOPS FOR PARKING BAYS. SUPPLY AND INSTALL TREATED HARDWOOD WHEEL STOPS AS DETAILED, OR AS OTHERWISE DIRECTED BY THE SUPERINTENDENT. WHEEL STOPS TO BE INSTALLED WITHIN COMPACTED GRANITIC SAND AREA FOR PARKING BAYS, INTO CONCRETE FOOTING. LAYOUT OF TIMBER WHEEL STOPS AND FIXING METHOD TO BE CONFIRMED ONSITE WITH SUPERINTENDENT.

#### **FENCING - REFER LCD-600 SERIES**

#### FENCE TYPE 1 (FF01) - STEEL HOOP FENCE

SUPPLY AND INSTALL FABRICATED HOOPS AS DETAILED. HOOP MATERIAL TO BE SMOOTH AND FREE OF SHARP EDGES. ENSURE HOOPS ARE INSTALLED INTO SOLID GROUND/FOOTINGS AS DETAILED OR OTHERWISE ADVISED BY SUPERINTENDENT. ANY HOOPS THAT MOVE WILL BE REJECTED. INSTALLATION TO BE APPROVED BY THE SUPERINTENDENT.

#### STRUCTURES - REFER LCD-600 SERIES SERIES,LCD-906

ALL TIMBER TO BE WEATHER TREATED WITH A COUNCIL APPROVED PRODUCT.

#### STRUCTURE TYPE 1 (ST01) - BRIDGE (PEDESTRIAN)

SUPPLY AND INSTALL BRIDGE WITH MODWOOD DECK AND CONCRETE FOOTINGS IN ACCORDANCE WITH DRAWINGS. ALL DECK SIZES AND CONNECTIONS ARE TO COMPLY WITH AUSTRALIAN STANDARDS. FRAME IS TO BE CONSTRUCTED TO AUSTRALIAN STANDARDS AND NATIONAL CONSTRUCTION CODE (NCC). DECK FRAMING IS TO BE CONFIRMED BY SUPERINTENDENT

CONTRACTOR TO UNDERTAKE ANY NECESSARY EXCAVATION AS PART OF THIS WORK IN ORDER TO BUILD BOARDWALK. CONTRACTOR TO MAKE GOOD OF ADJACENT SURFACES UPON COMPLETION OF WORKS.

FOOTING HOLES FOR POSTS SHALL BE EXCAVATED TO A MINIMUM DEPTH OF 700MM AND A MINIMUM WIDTH OF 400MM OR AS DIRECTED BY THE SUPERINTENDENT. CONCRETE IS TO BE 25MPA WETPOUR. BAGGED DRY-MIX IS NOT TO BE USED.

BRIDGE SURFACE TO BE MODWOOD DECKING ONLY. DECKING BOARDS SHALL BE SIZE AS NOMINATED. DECKING BOARDS ARE TO BE FRAMED ON THE EDGES ON THE BOARDWALK BY

MODWOOD EDGE DECKING AS DETAILED. MODWOOD DECKING COLOUR IS TO BE 'BLACKBEAN' UNLESS STATED BY THE SUPERINTENDENT.

JOISTS ARE TO BE SEASONED HARDWOOD OR AS DIRECTED BY THE SUPERINTENDENT AND PLACED AT 450MM CENTRES. BEARERS ARE TO BE SEASONED HARDWOOD OR AS DIRECTED BY THE SUPERINTENDENT AND INSTALLED AT 1500MM CENTRES.

FIXINGS. ALL SCREWS / BOLTS / BATTEN SCREWS ARE TO BE STAINLESS STEEL. ALL FIXINGS ARE TO BE COUNTER-SUNK SO TO BE FLUSH WITH THE SURFACE BEING FIXED. ALL FIXINGS ARE TO BE 75MM STAINLESS STEEL, FLAT-HEAD BATTEN SCREWS.

CONTRACTOR TO REFER TO COUNCIL ENGINEER RECOMMENDATIONS AND SPECIFICATION

ENSURE BRIDGE TO HAVE P4 SLIP RATING FOR THE PENDULUM TEST.

TIMBER LOGS ARE TO BE LOCALLY SOURCED HARDWOOD. SOURCE AND TYPE TO BE APPROVED BY SUPERINTENDENT. TIMBER TO BE SEASONED, CONSISTENT IN APPEARANCE, FREE OF ROT, CRACKS AND DEFECTS. TIMBER WILL BE REJECTED OTHERWISE. ALL EDGES AND FACES TO BE ROUNDED AND SANDED SMOOTH. ALL BARK TO BE STRIPPED OFF PRIOR TO INSTALLATION. APPLY BLACK NON-TOXIC TIMBER PROTECTOR TO ALL PARTS BELOW GROUND. TIMBER PROTECTOR MUST NOT BE VISIBLE ABOVE FINISHED SURFACE LEVEL MAKING ALLOWANCE FOR SLUMPING. LOCATION OF LOGS SHOWN ON PLAN ARE INDICATIVE AND ALL LOCATIONS TO BE CONFIRMED ON-SITE WITH SUPERINTENDENT. ALL LOGS ARE TO BE INSTALLED OUTSIDE OF PLAY EQUIPMENT FALL ZONE.

SUPPLY AND INSTALL NOMINAL 600-700MM DIAMETER LOG AS SEATS, WITH A MIN 350 - MAX 450mm OUT OF GROUND. APPLY NON-TOXIC TIMBER PROTECTOR TO ALL PARTS BELOW GROUND. INSTALL INTO COMPACTED FCR BASE AND CONCRETE MORTAR HAUNCH TO STABILISE AND PREVENT ROT.

SUPPLY, CUT AND INSTALL 400-500mm DIA LOG STEPPERS AS SHOWN. TO BE CAST INTO CONCRETE FOOTING AS DETAILED. APPLY NON-TOXIC TIMBER PROTECTOR TO ALL PARTS BELOW GROUND. ANY LOGS THAT MOVE WILL BE REJECTED.

#### BOULDER / BOULDER BENCH / BOULDER -STEPPING STONE

ALL BOULDERS ARE TO BE SOURCED FROM A SUITABLY APPROVED LOCAL QUARRY OR CARTAGE AS SALVAGED BOULDERS FROM NOMINATED LOCATION FROM COUNCIL DEPOT IF SUITABLE AND AVAILABLE. BOULDERS TO BE BLUESTONE BOULDERS. DIMENSIONS TO COMPLY WITH BOULDERS AS NOMINATED WITHIN THE DETAILS. INSTALL IN LOCATIONS AS INDICATED ON THE LANDSCAPE DRAWINGS. ALL BOULDER EDGES AND FEATURE STONE BOULDERS ARE TO BE INSTALLED TO APPEAR 'NATURAL'.

BOULDERS ARE TO BE INSTALLED WITH MINIMUM ONE THIRD OF BOULDER BURIED INTO COMPACTED SUBGRADE. MORTAR HAUNCH MAY BE USED UNDER SURFACE LEVEL AND SECURED, IF NATURAL STONE DOES NOT ALLOW REQUIRED HEIGHT OUT OF GROUND, UNLESS OTHERWISE DOCUMENTED. ENSURE NO SHARP EDGES OR PROTRUSIONS TO OUTER FACE.

BOULDERS SHALL BE OF SOUND, DURABLE MATERIAL, NATURAL, NATIVE, INDIGENOUS SELECTED STONES AND BOULDERS TYPICAL OF THE REGION. NO BOULDERS OR STONES SHALL BE TAKEN FROM THE CREEK BED OR BANKS OR OTHER UNDISTURBED AREAS. THEY SHALL BE ROUGHLY ROUND, FIELD, FOR ROCK BEACHING AREAS AND ROUGHLY CUBIC FOR STONE WALLS AND FEATURE STONE BOULDERS, OR OTHER VARYING SHAPES WITH THE DIMENSIONS IN ACCORDANCE WITH THE LANDSCAPE DRAWINGS.

BOULDER BENCH. BOULDERS ARE TO BE 450mm OUT OF GROUND, UNLESS OTHERWISE DOCUMENTED. BOULDER TO INCLUDE SAWN CUT TOP SURFACE THAT IS LEVEL AS SHOWN IN DETAILS. ALL GAPS 10-120MM WIDE BETWEEN BOULDERS TO BE FILLED WITH MORTAR OR AS INSTRUCTED BY THE SUPERINTENDENT. MATCH COLOUR TINT OF MORTAR TO BOULDERS.

POLLEN

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**WARNING** 

Landscape Architect.

FOR CONSTRUCTION

- Beware of underground services. Locations of underground services are indicative only. Their exact position should be proven on site.

 Contractor to verify all dimensions on site before commencing work. - Report all discrepancies to Superintendent prior to construction. - Figured dimensions to be taken in preference to scaled drawings.

- All drawings may not be distributed without prior permission from the

**PROJECT** YARRALUMLA RESERVE Capital Works

CLIENT Frankston City Council 30 Davey Street, Frankston VIC 3199


PLAN NUMBER P355/001 **Construction Support** JOB NUMBER DRAWING TITLE 211006 **Performance Notes** 


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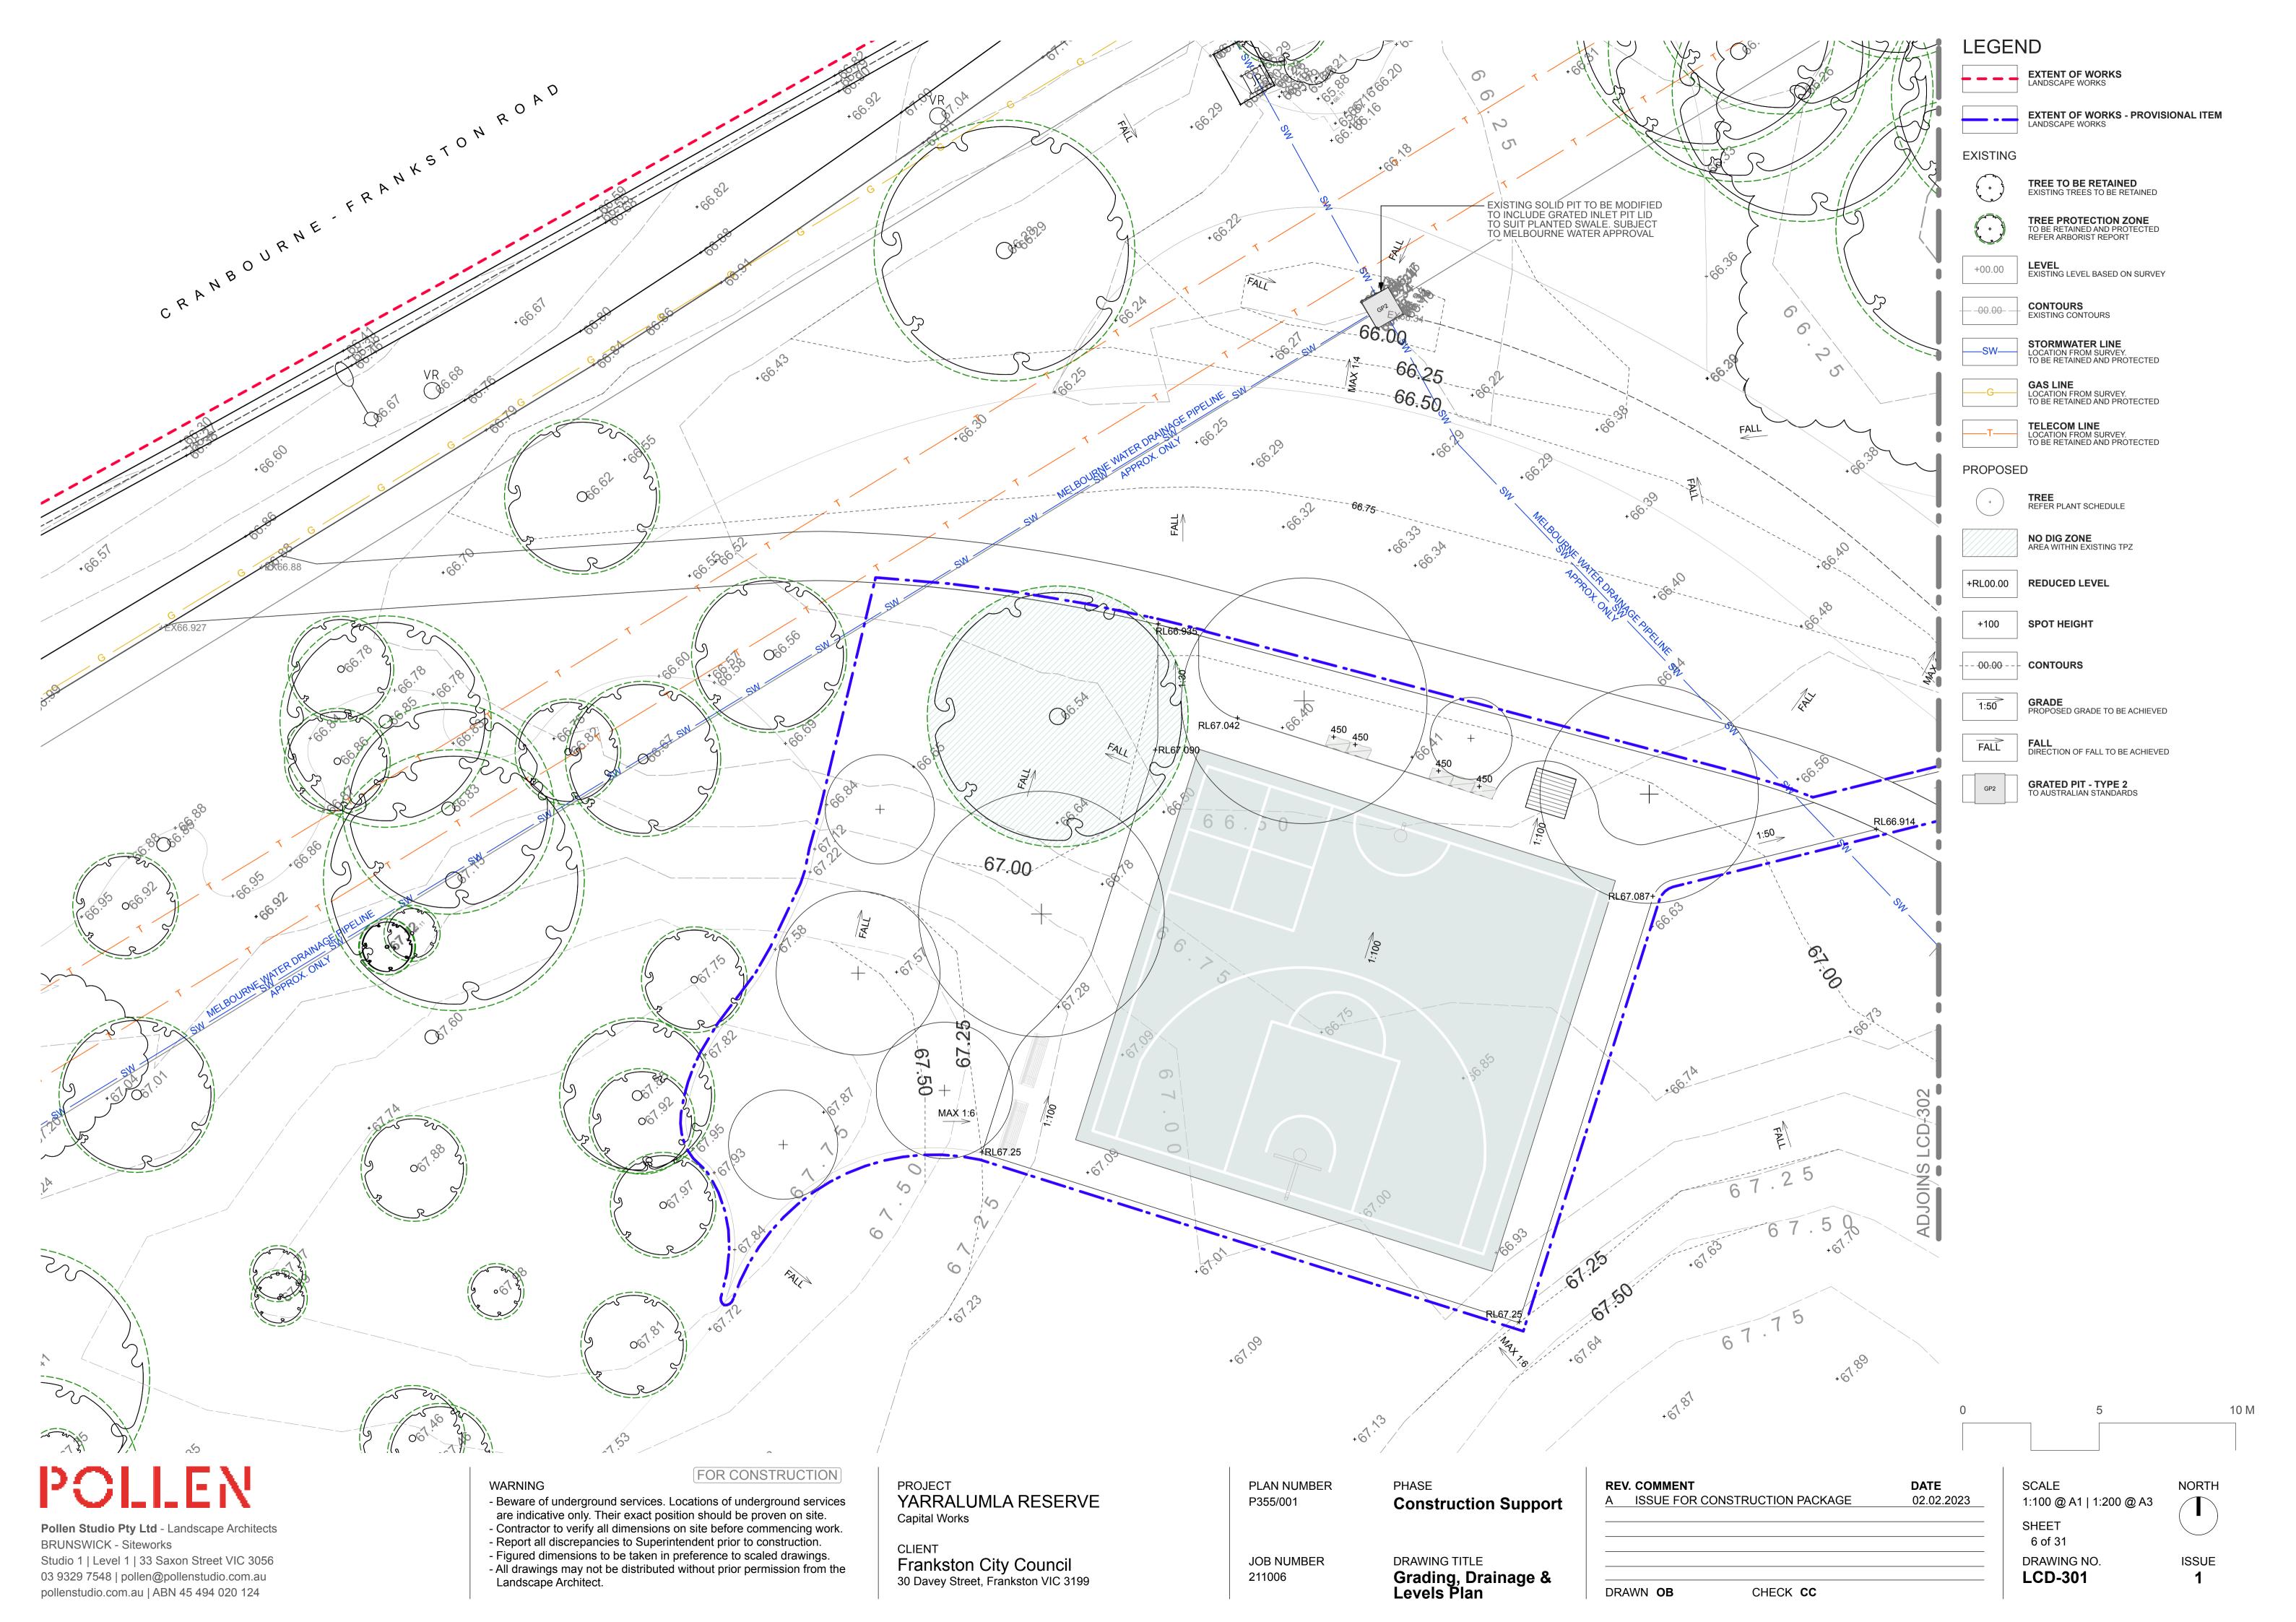
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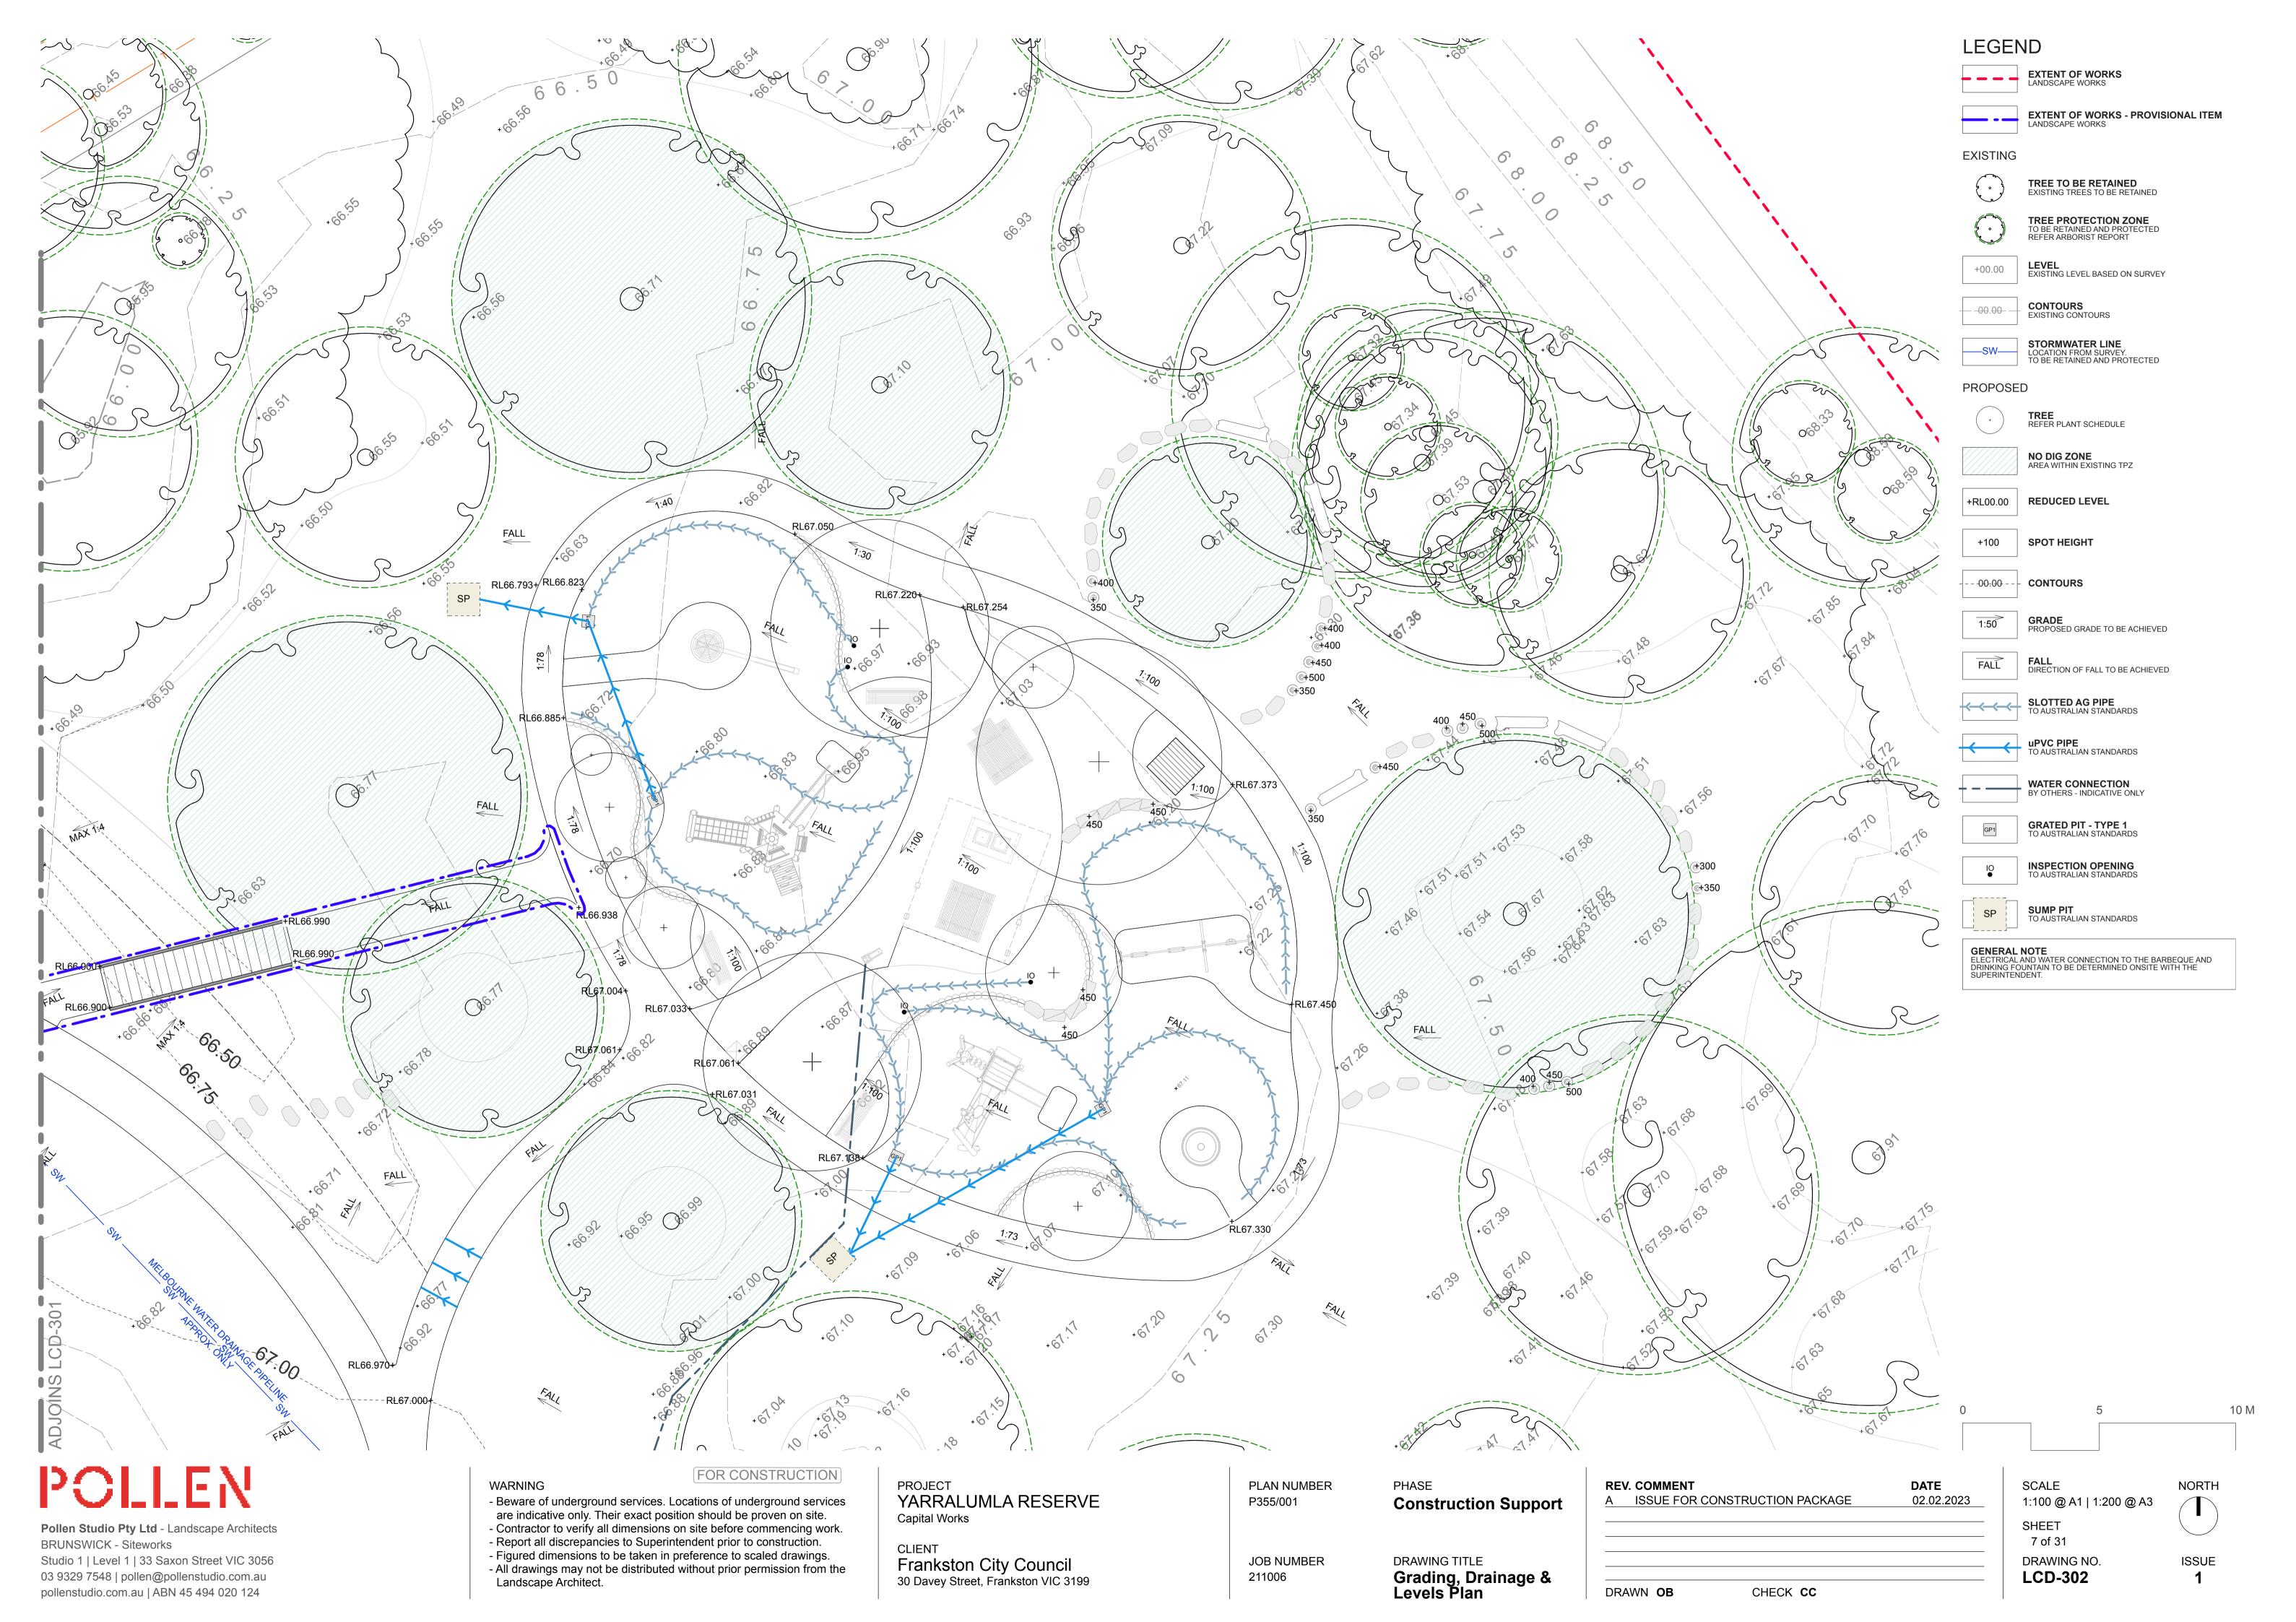
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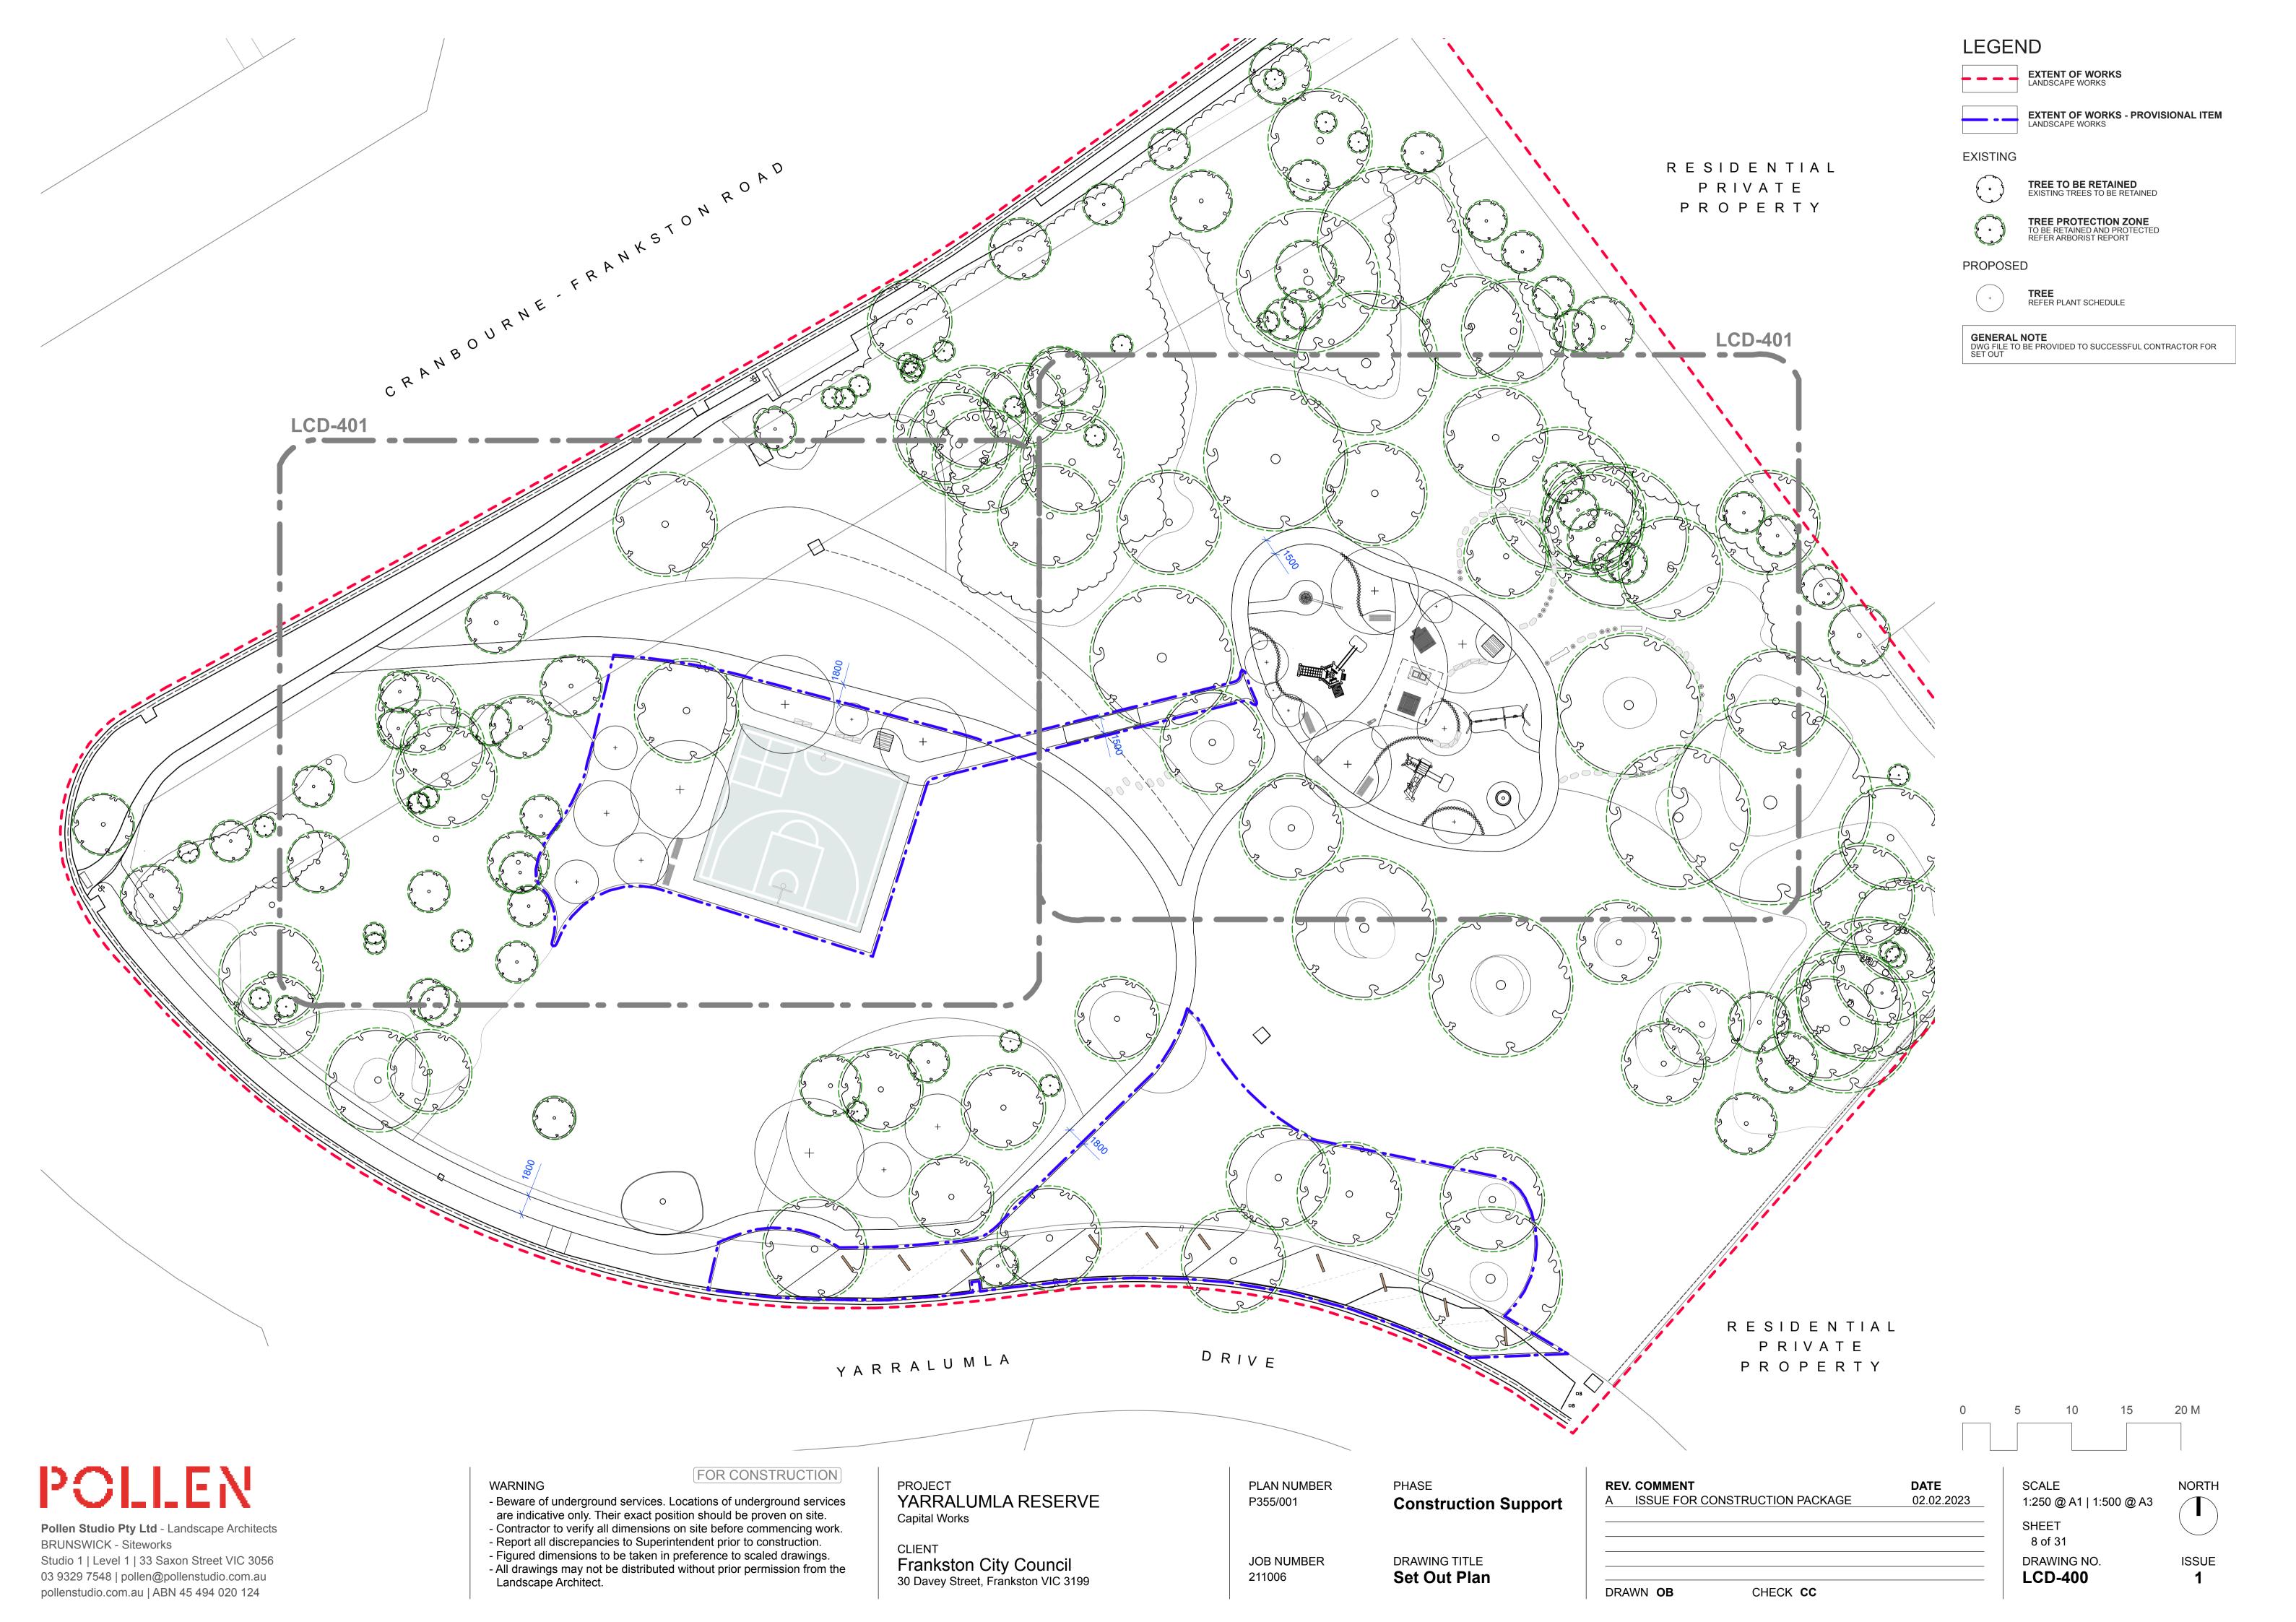
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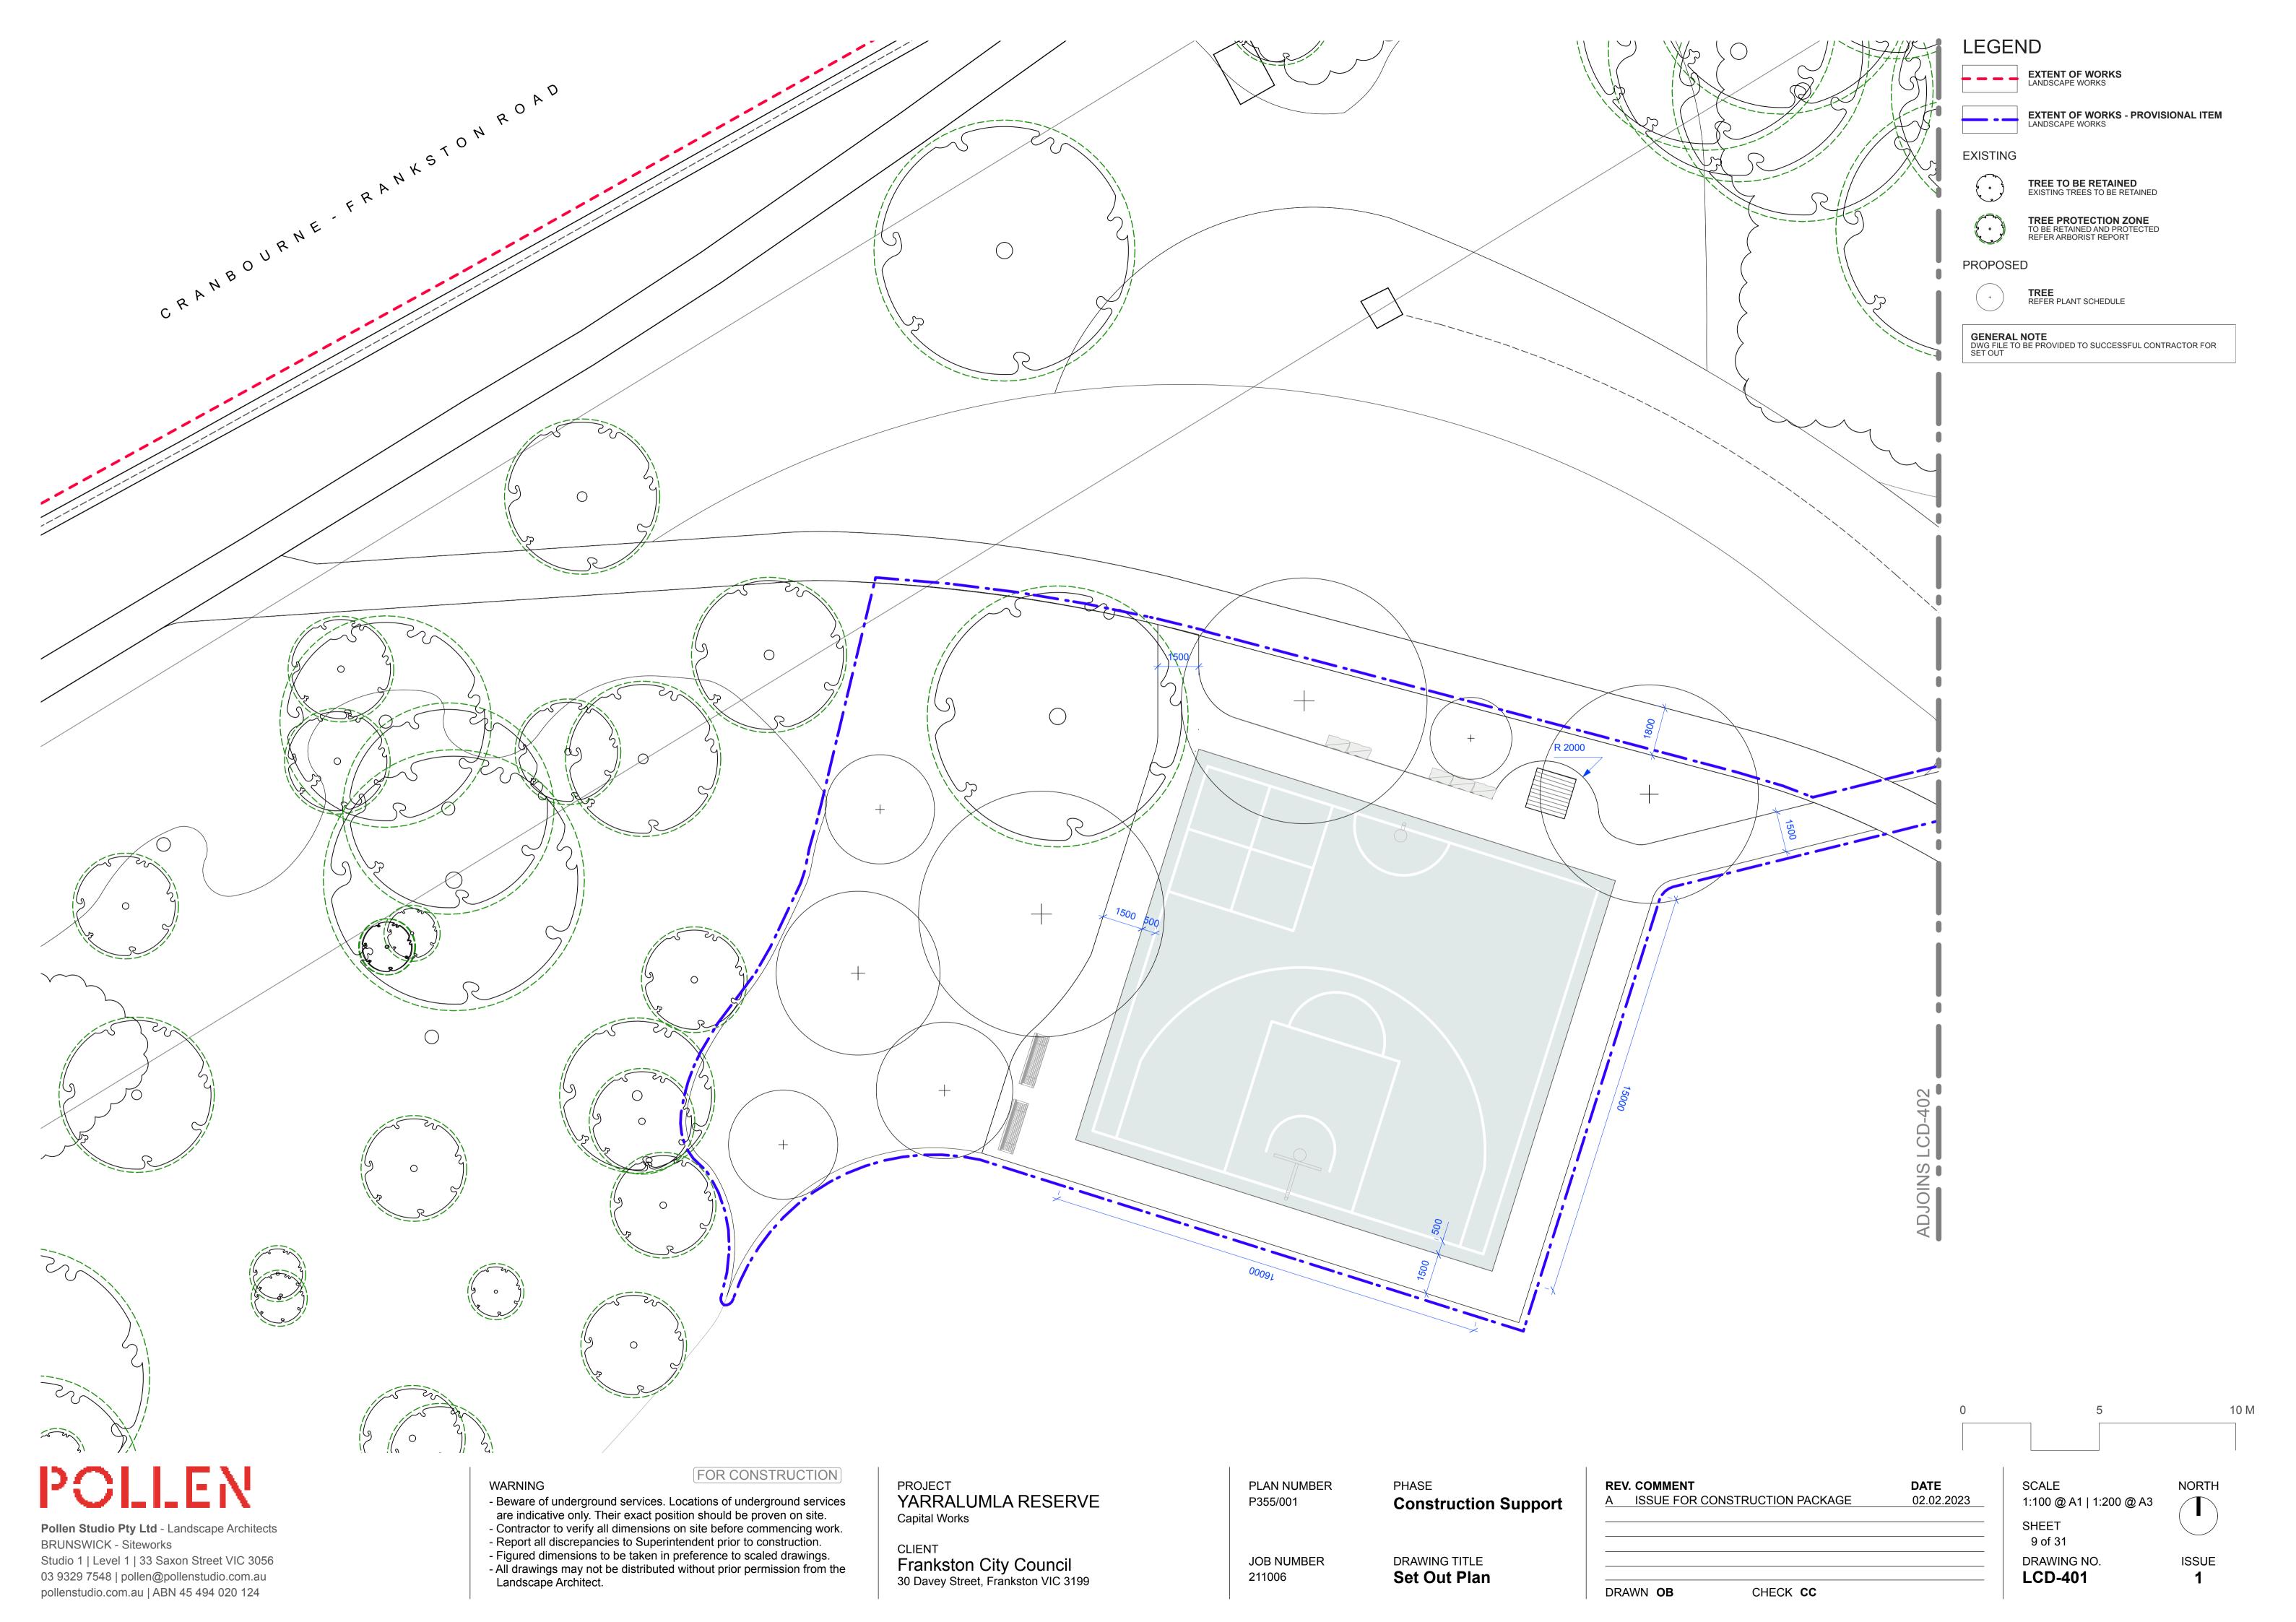











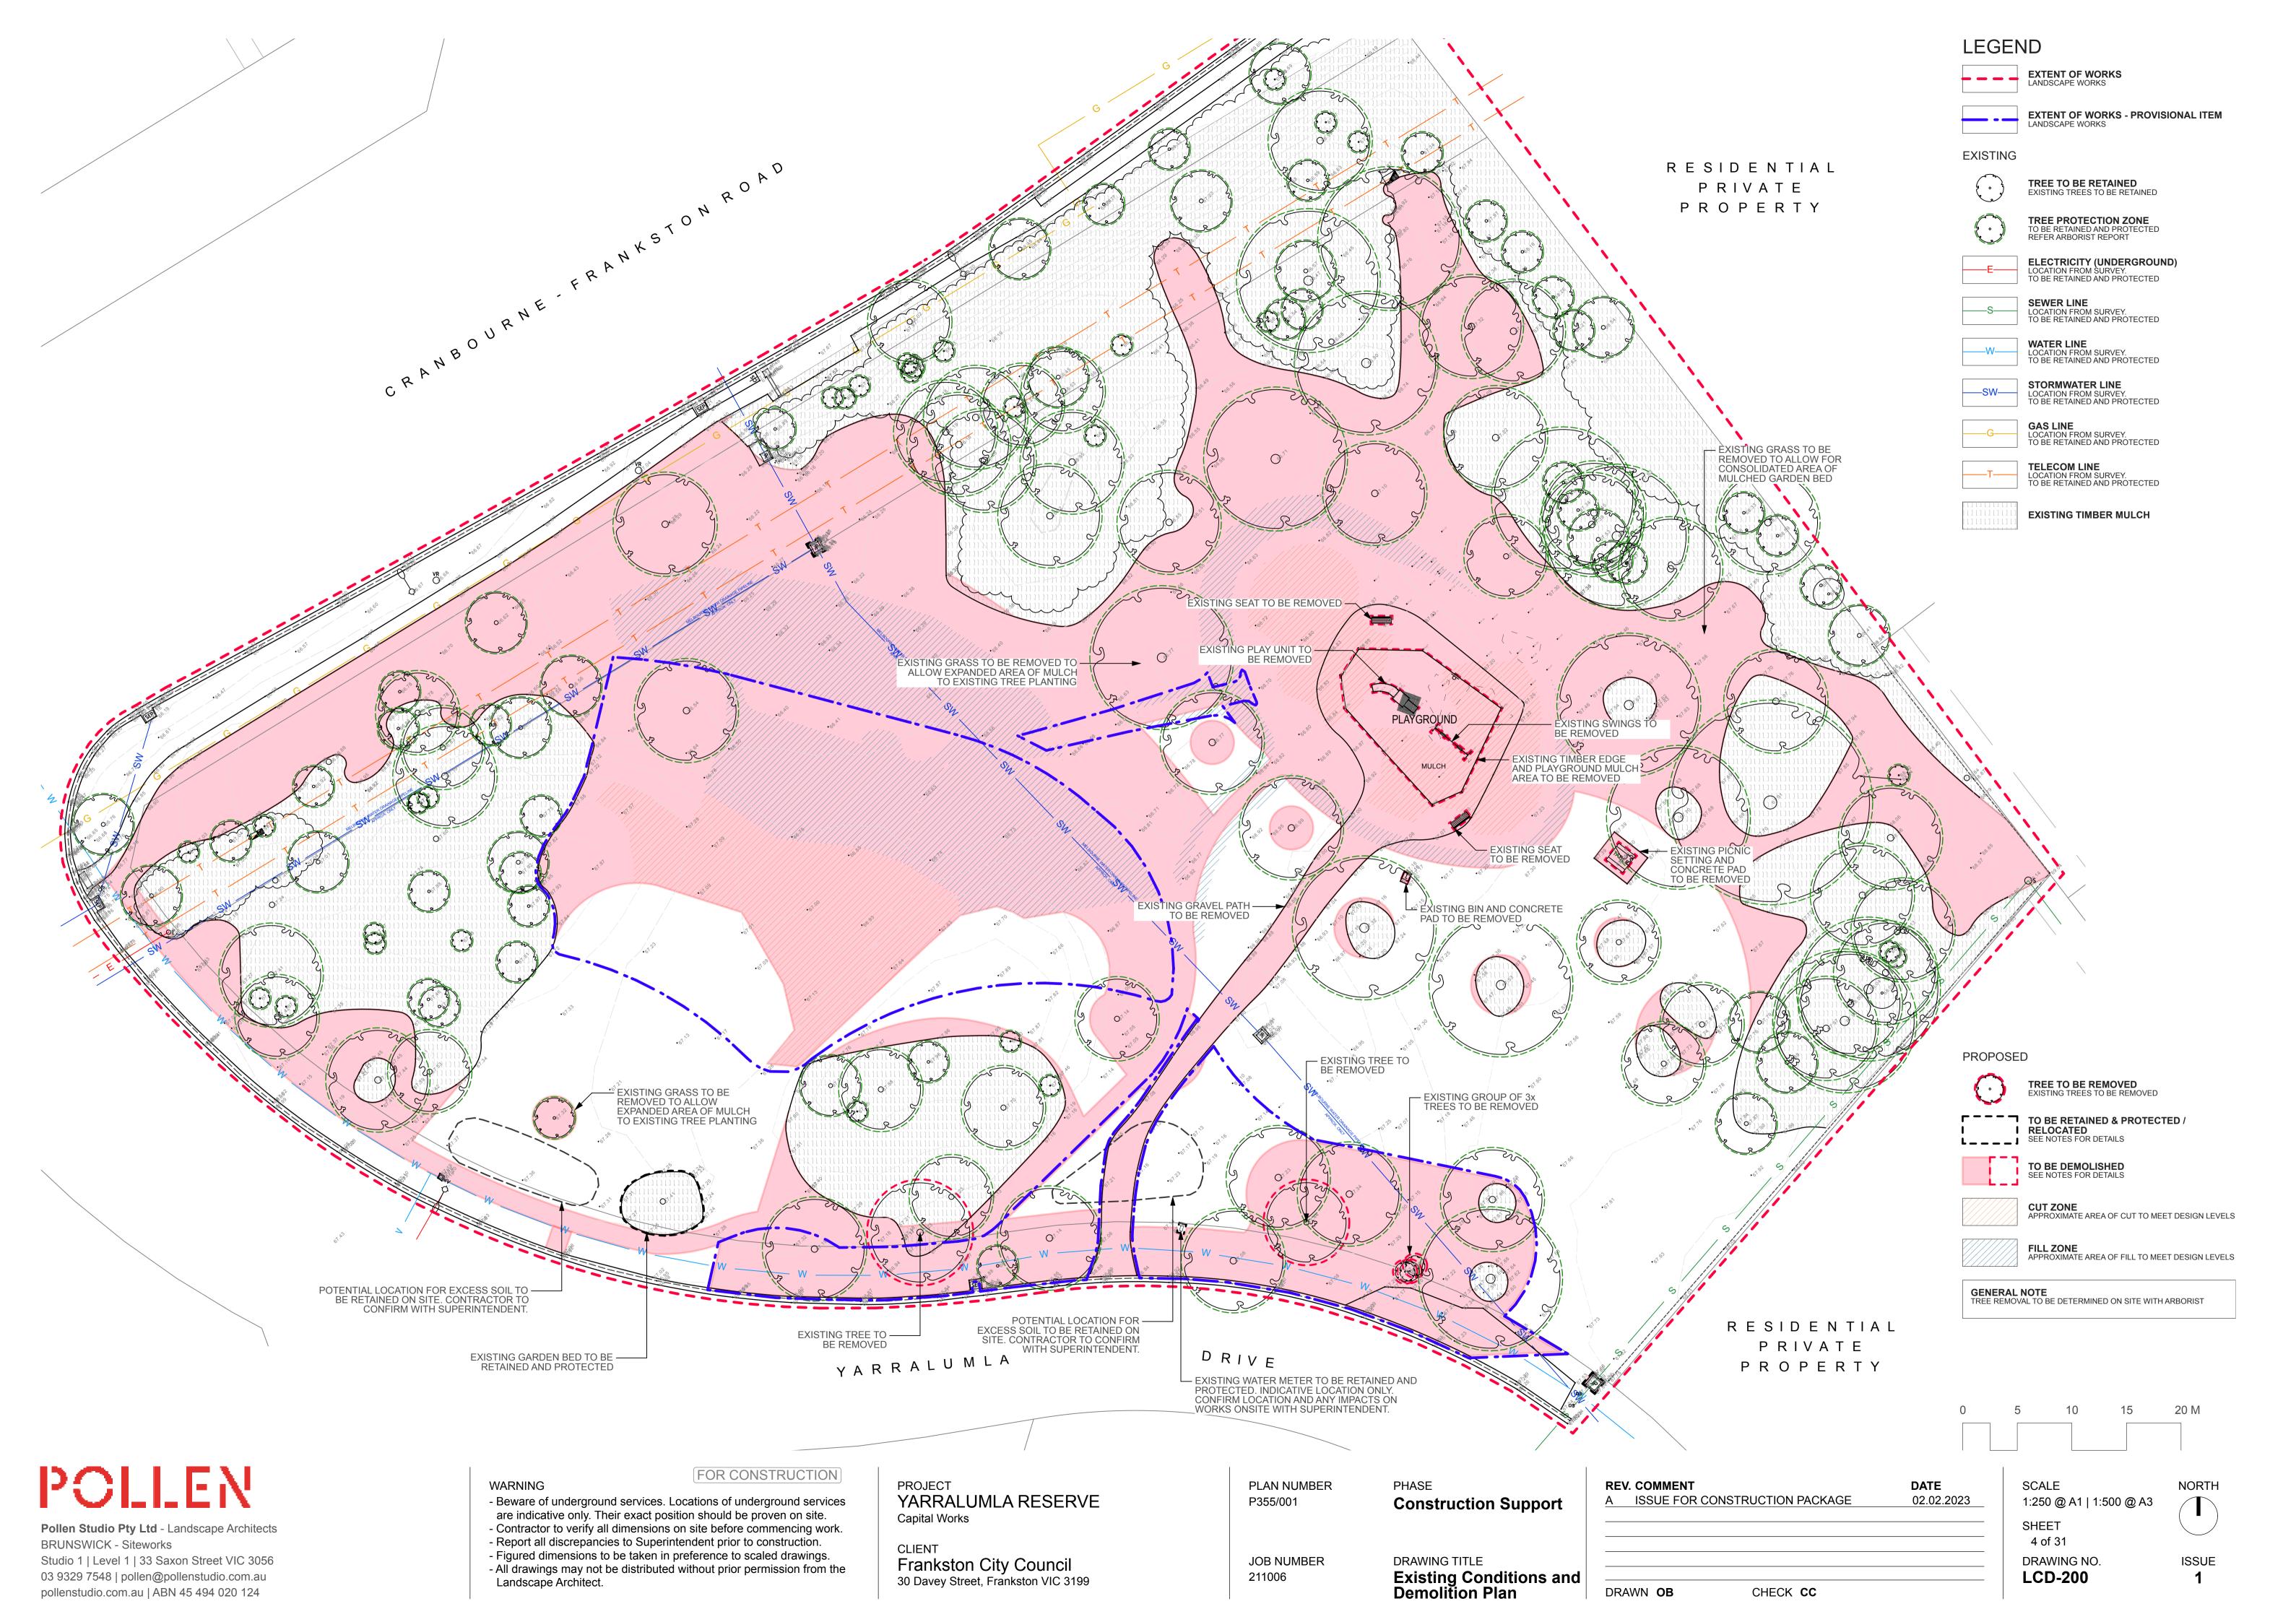


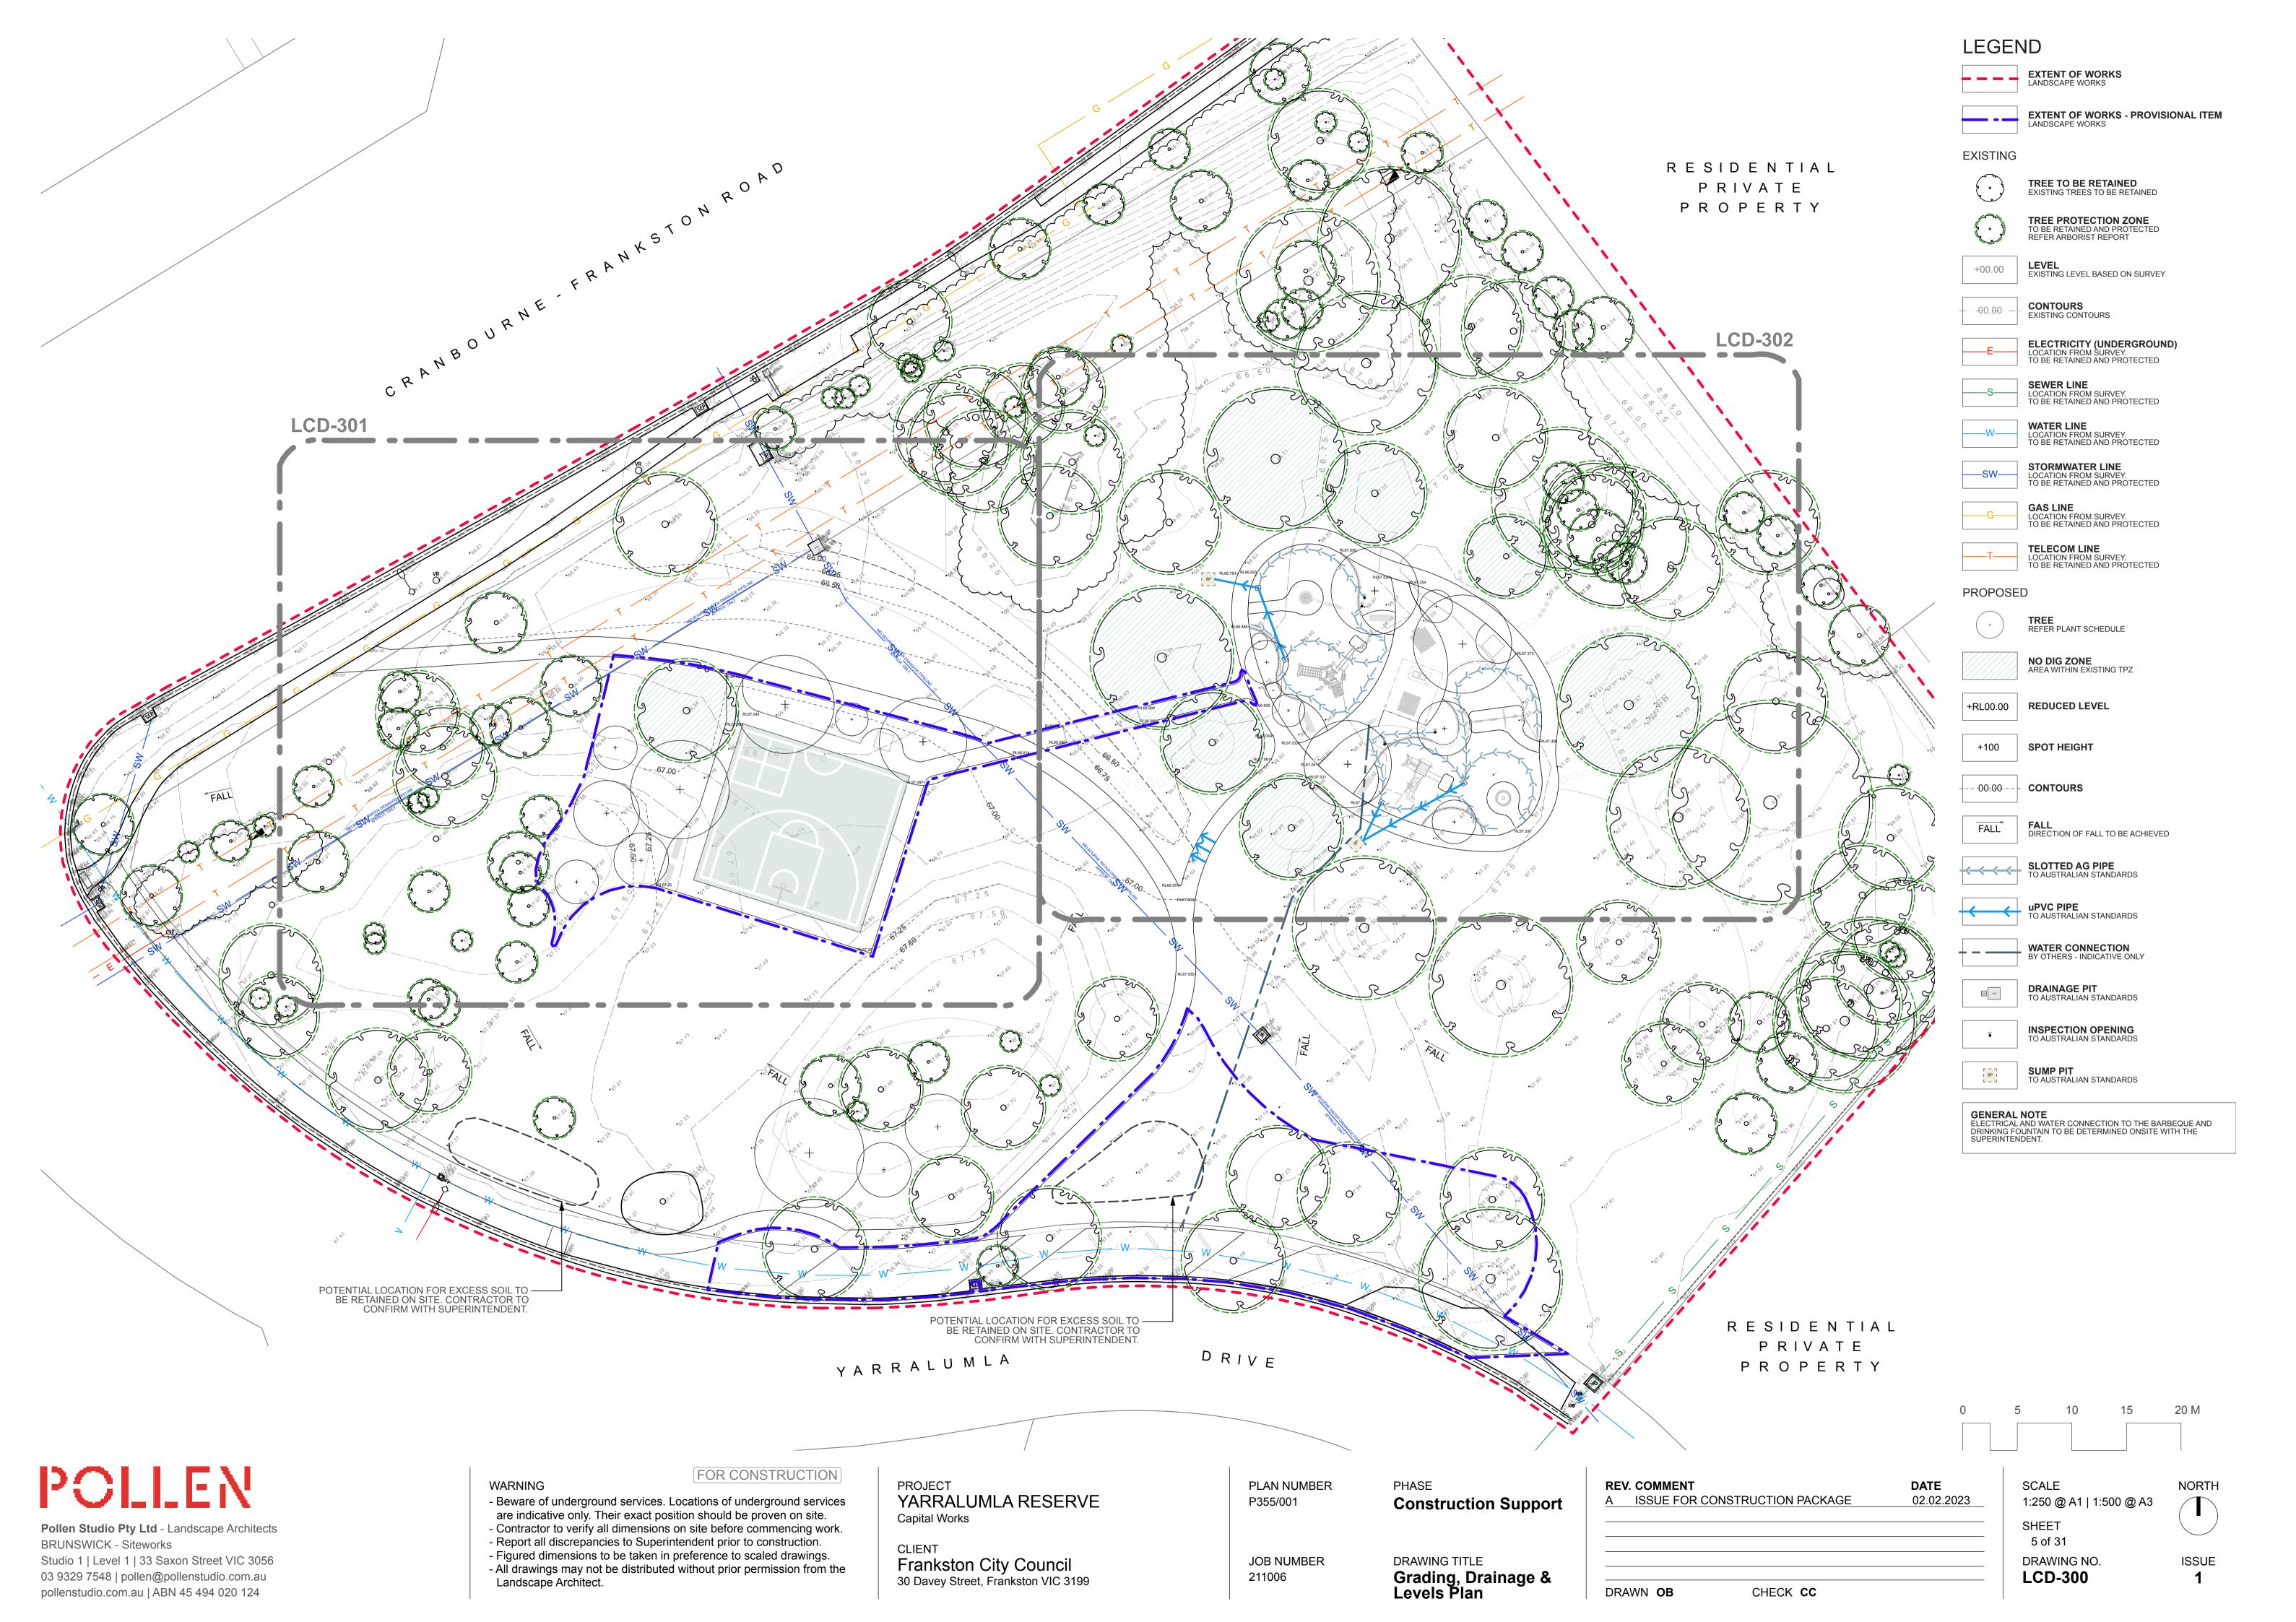


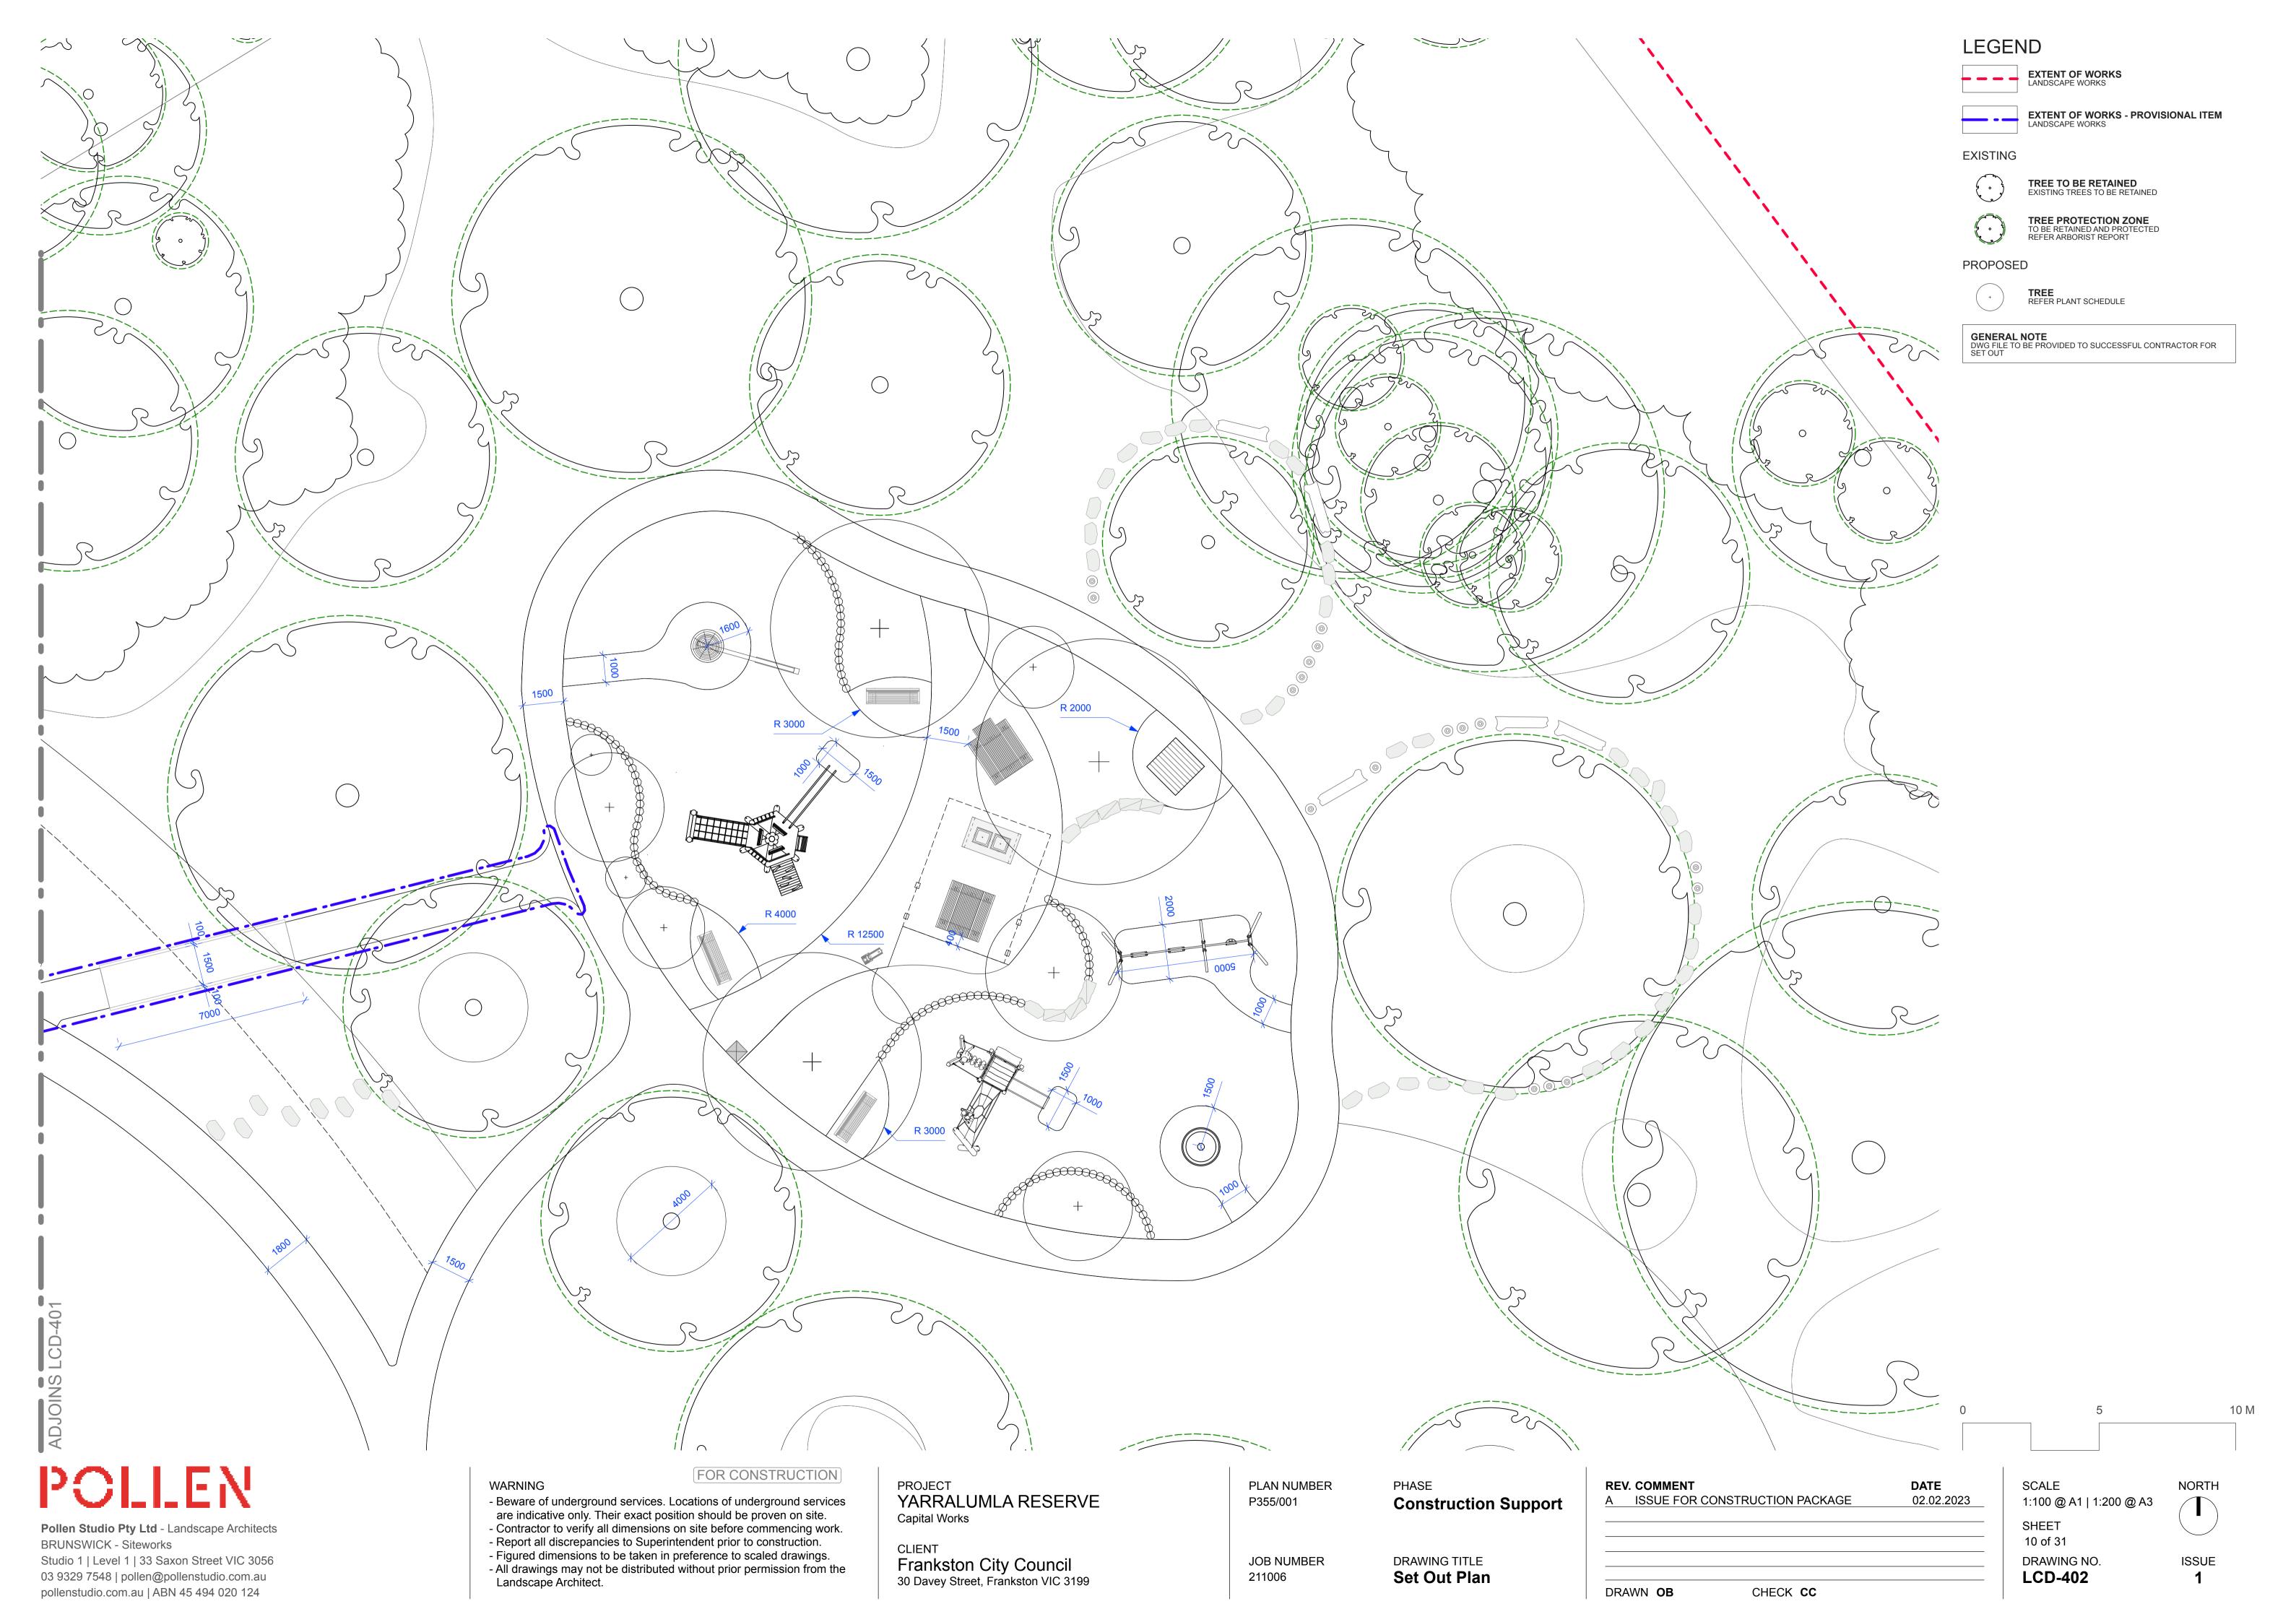


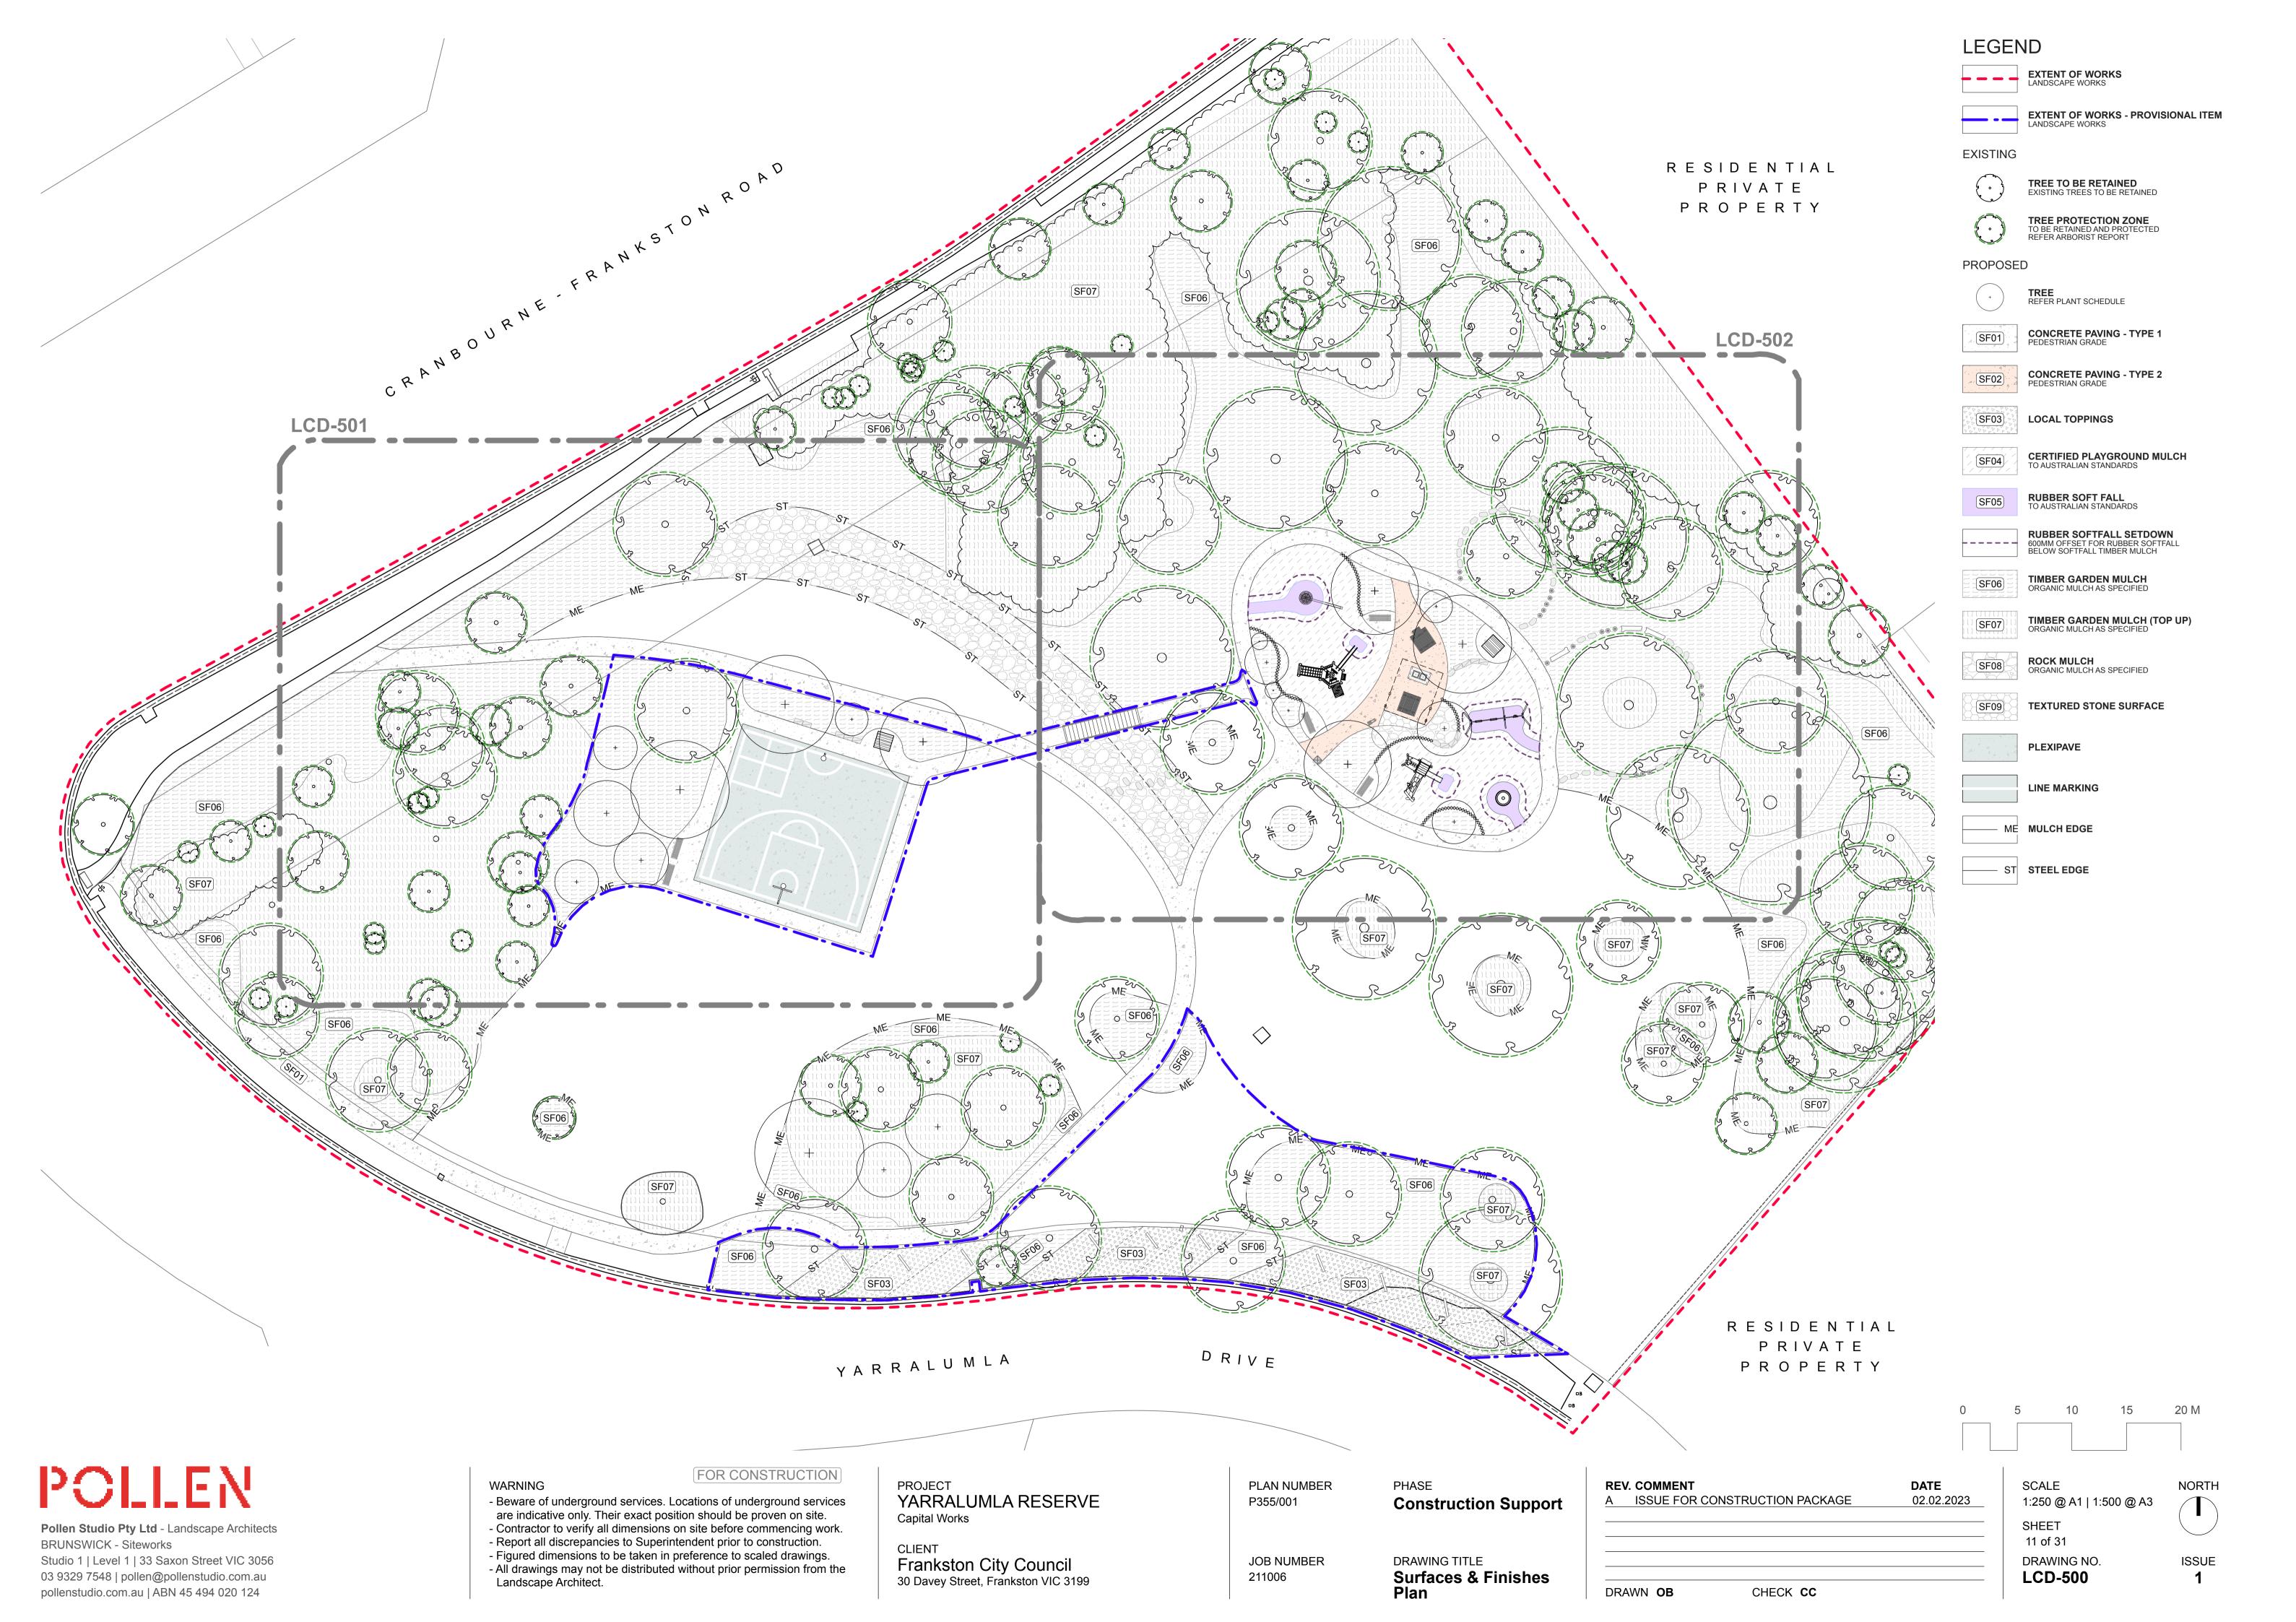


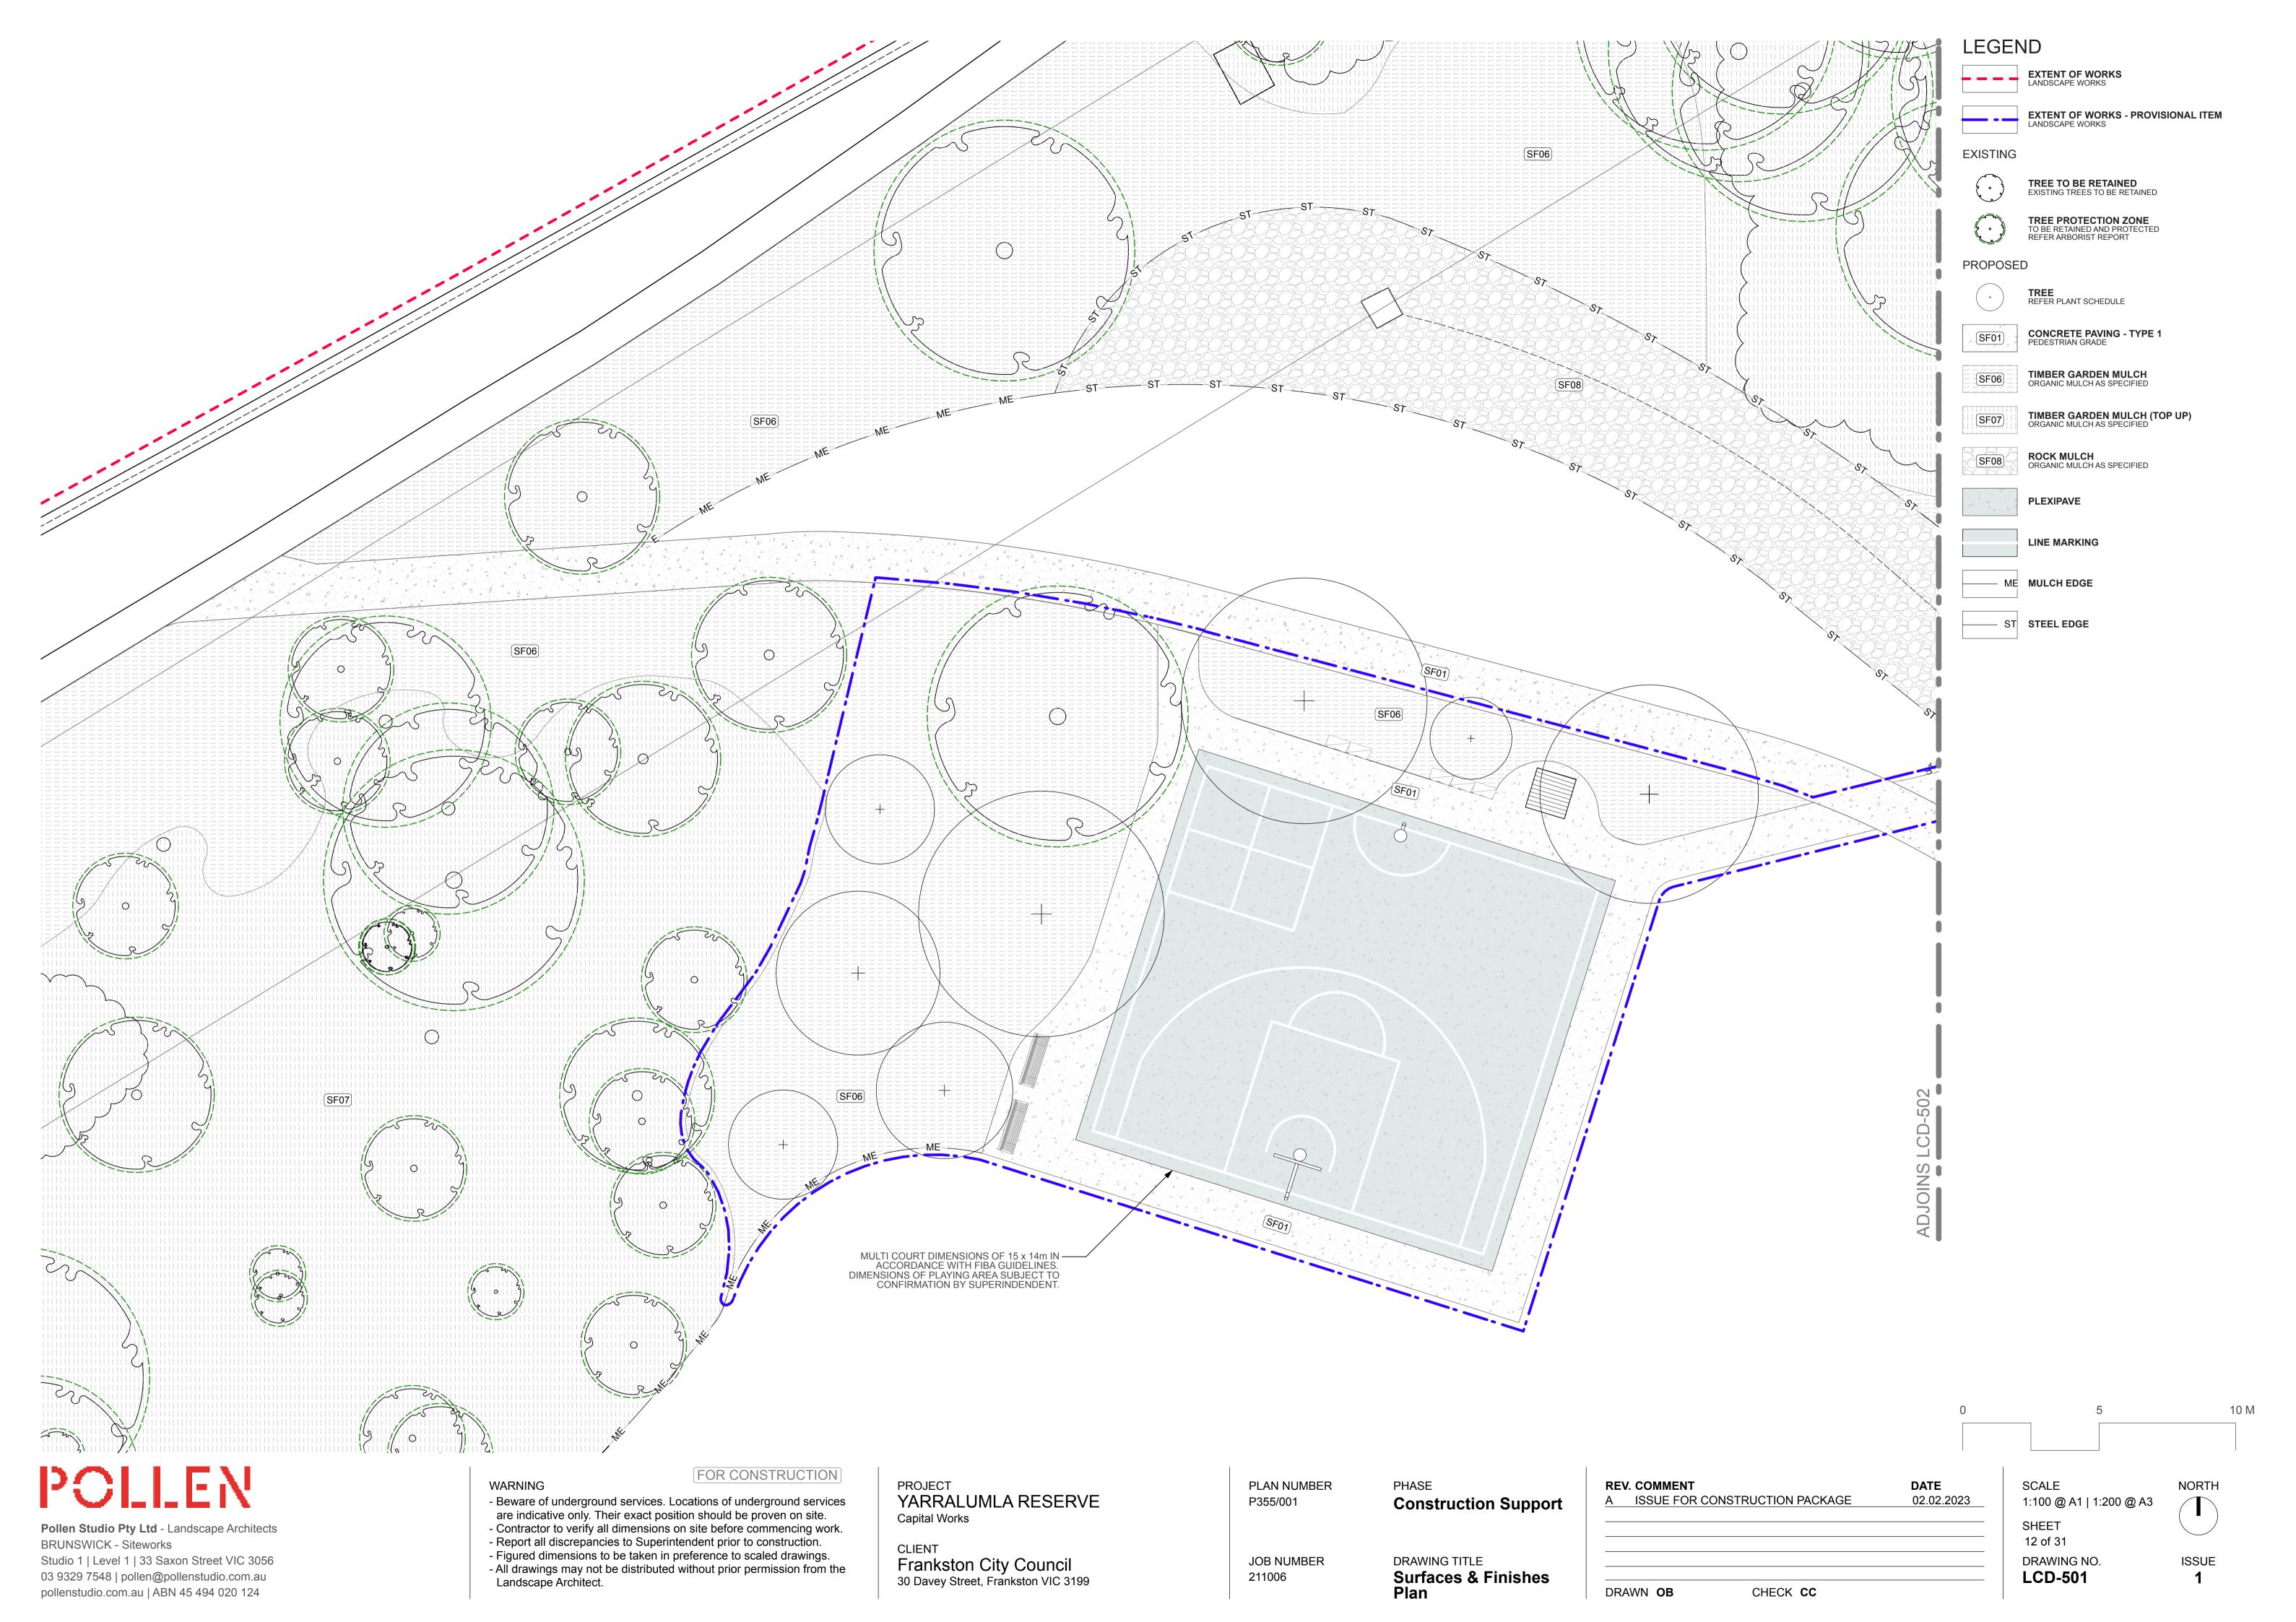


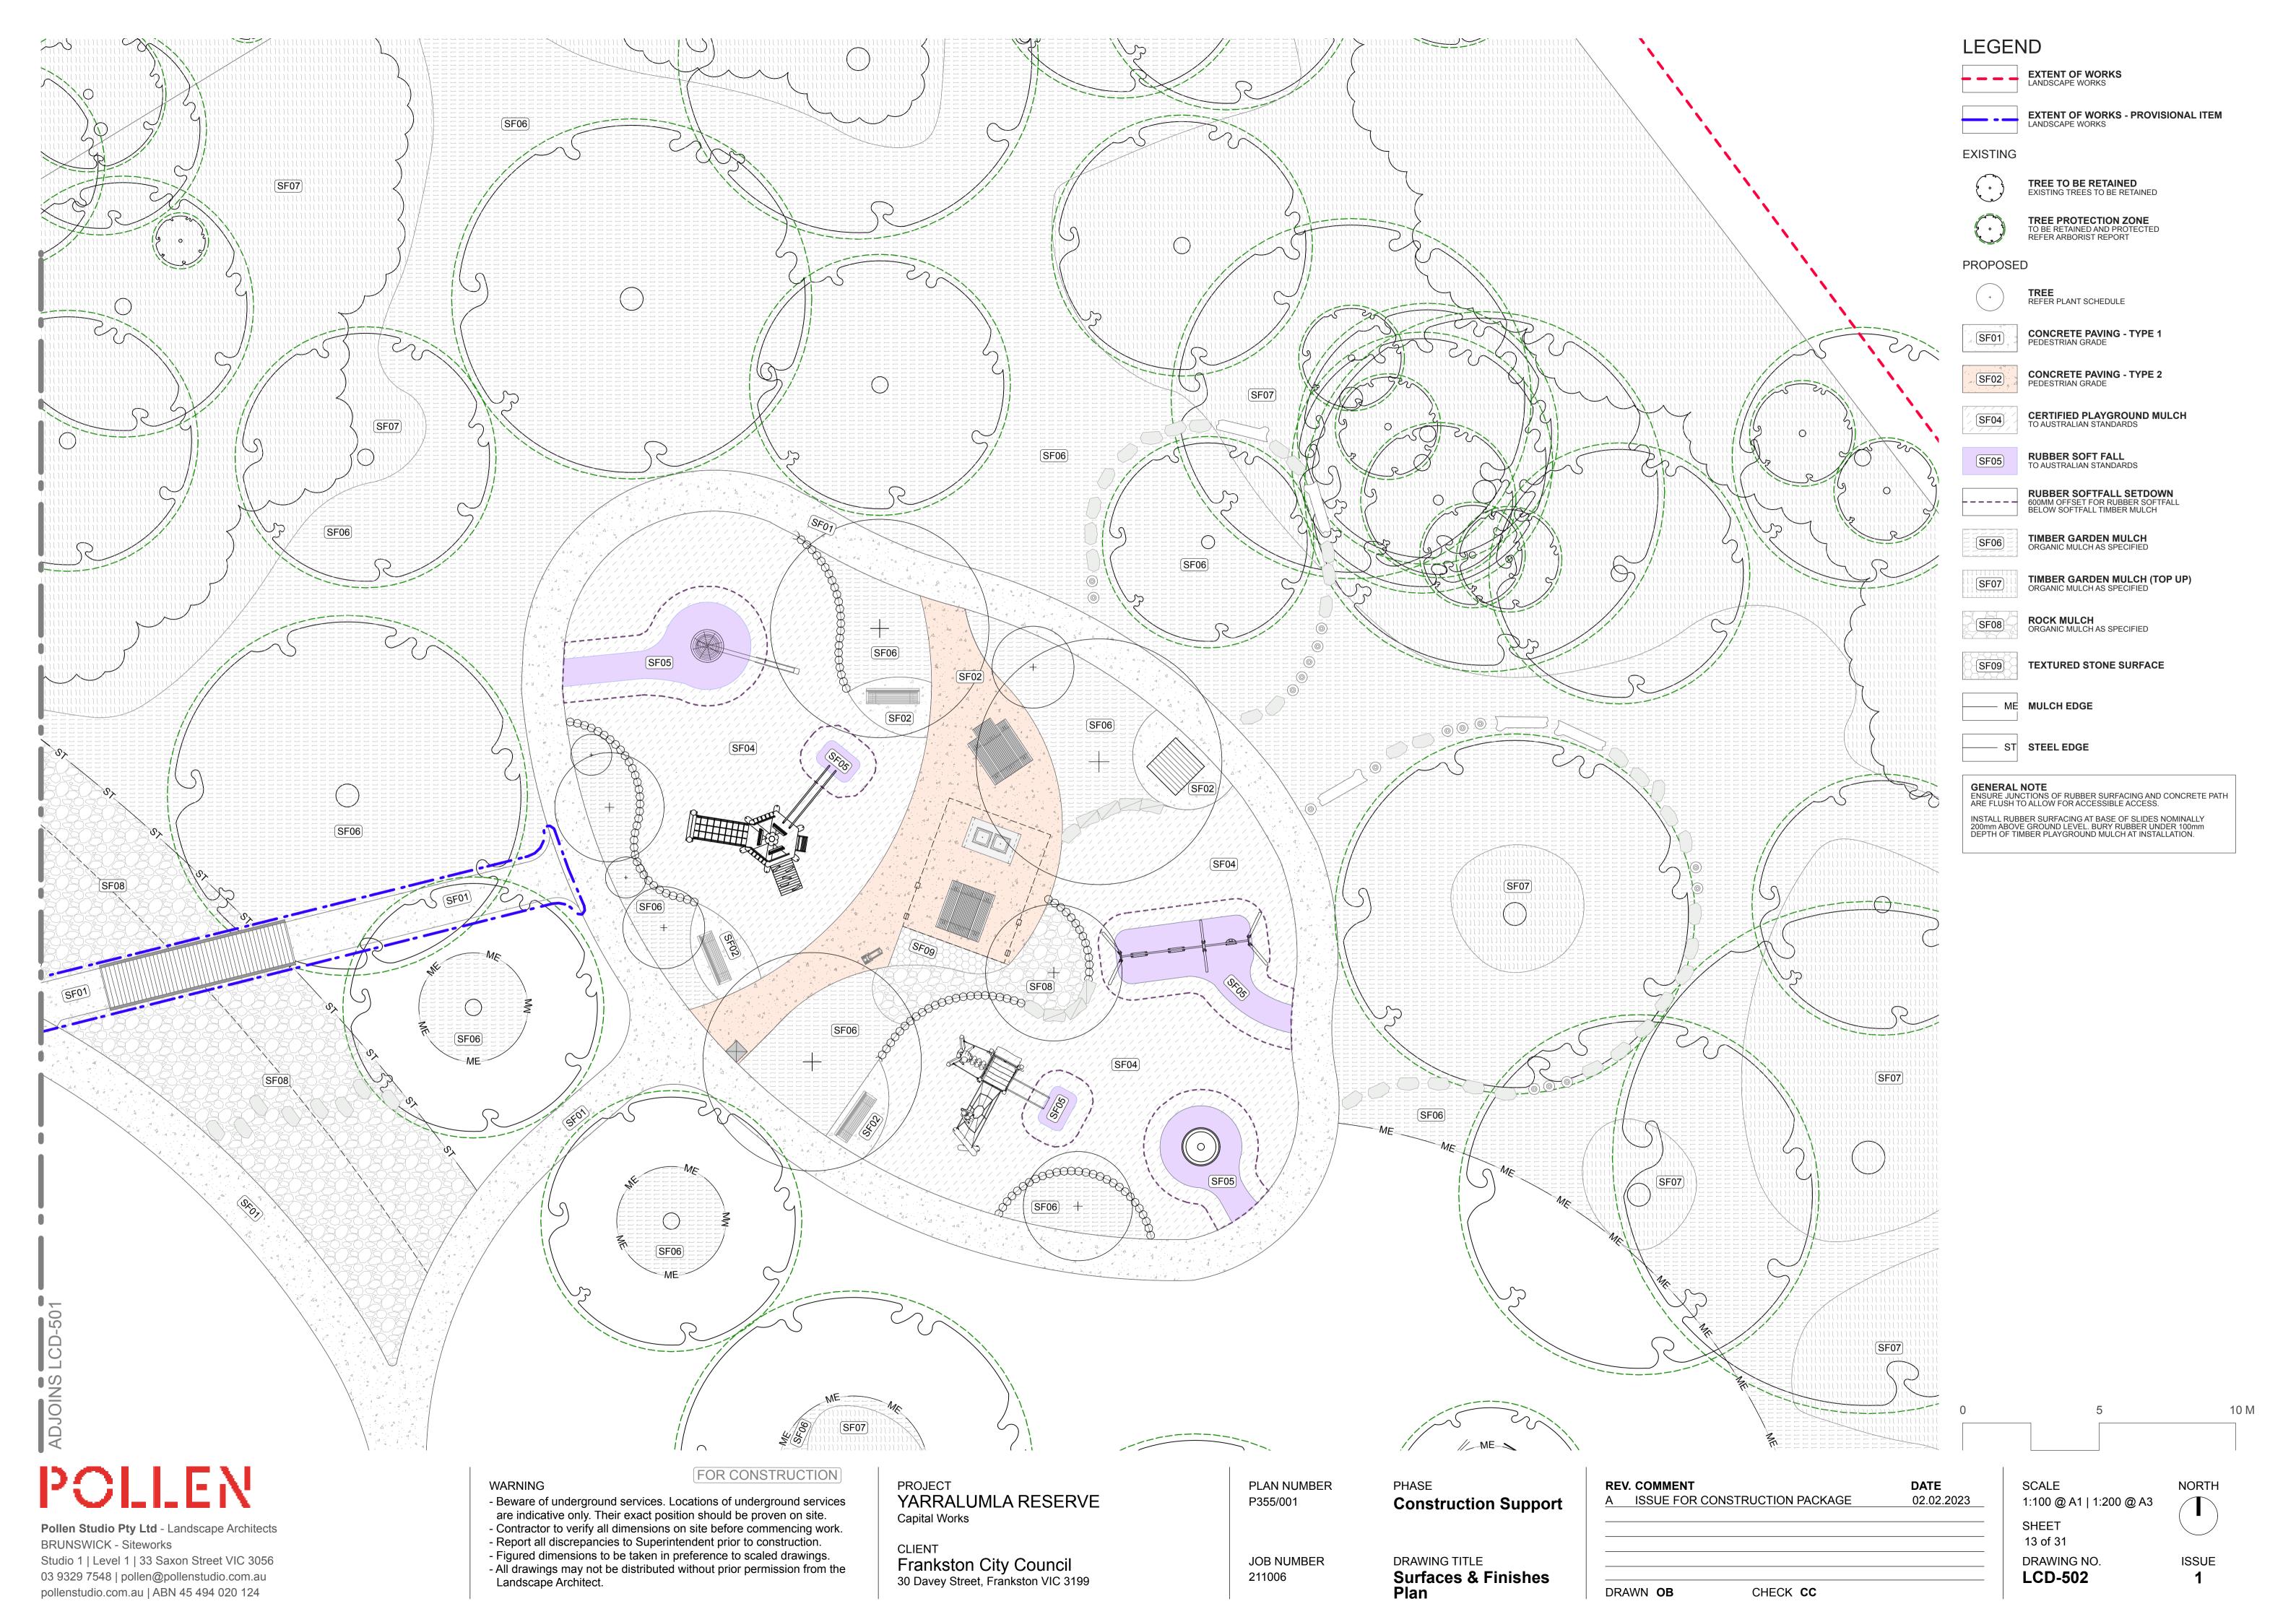


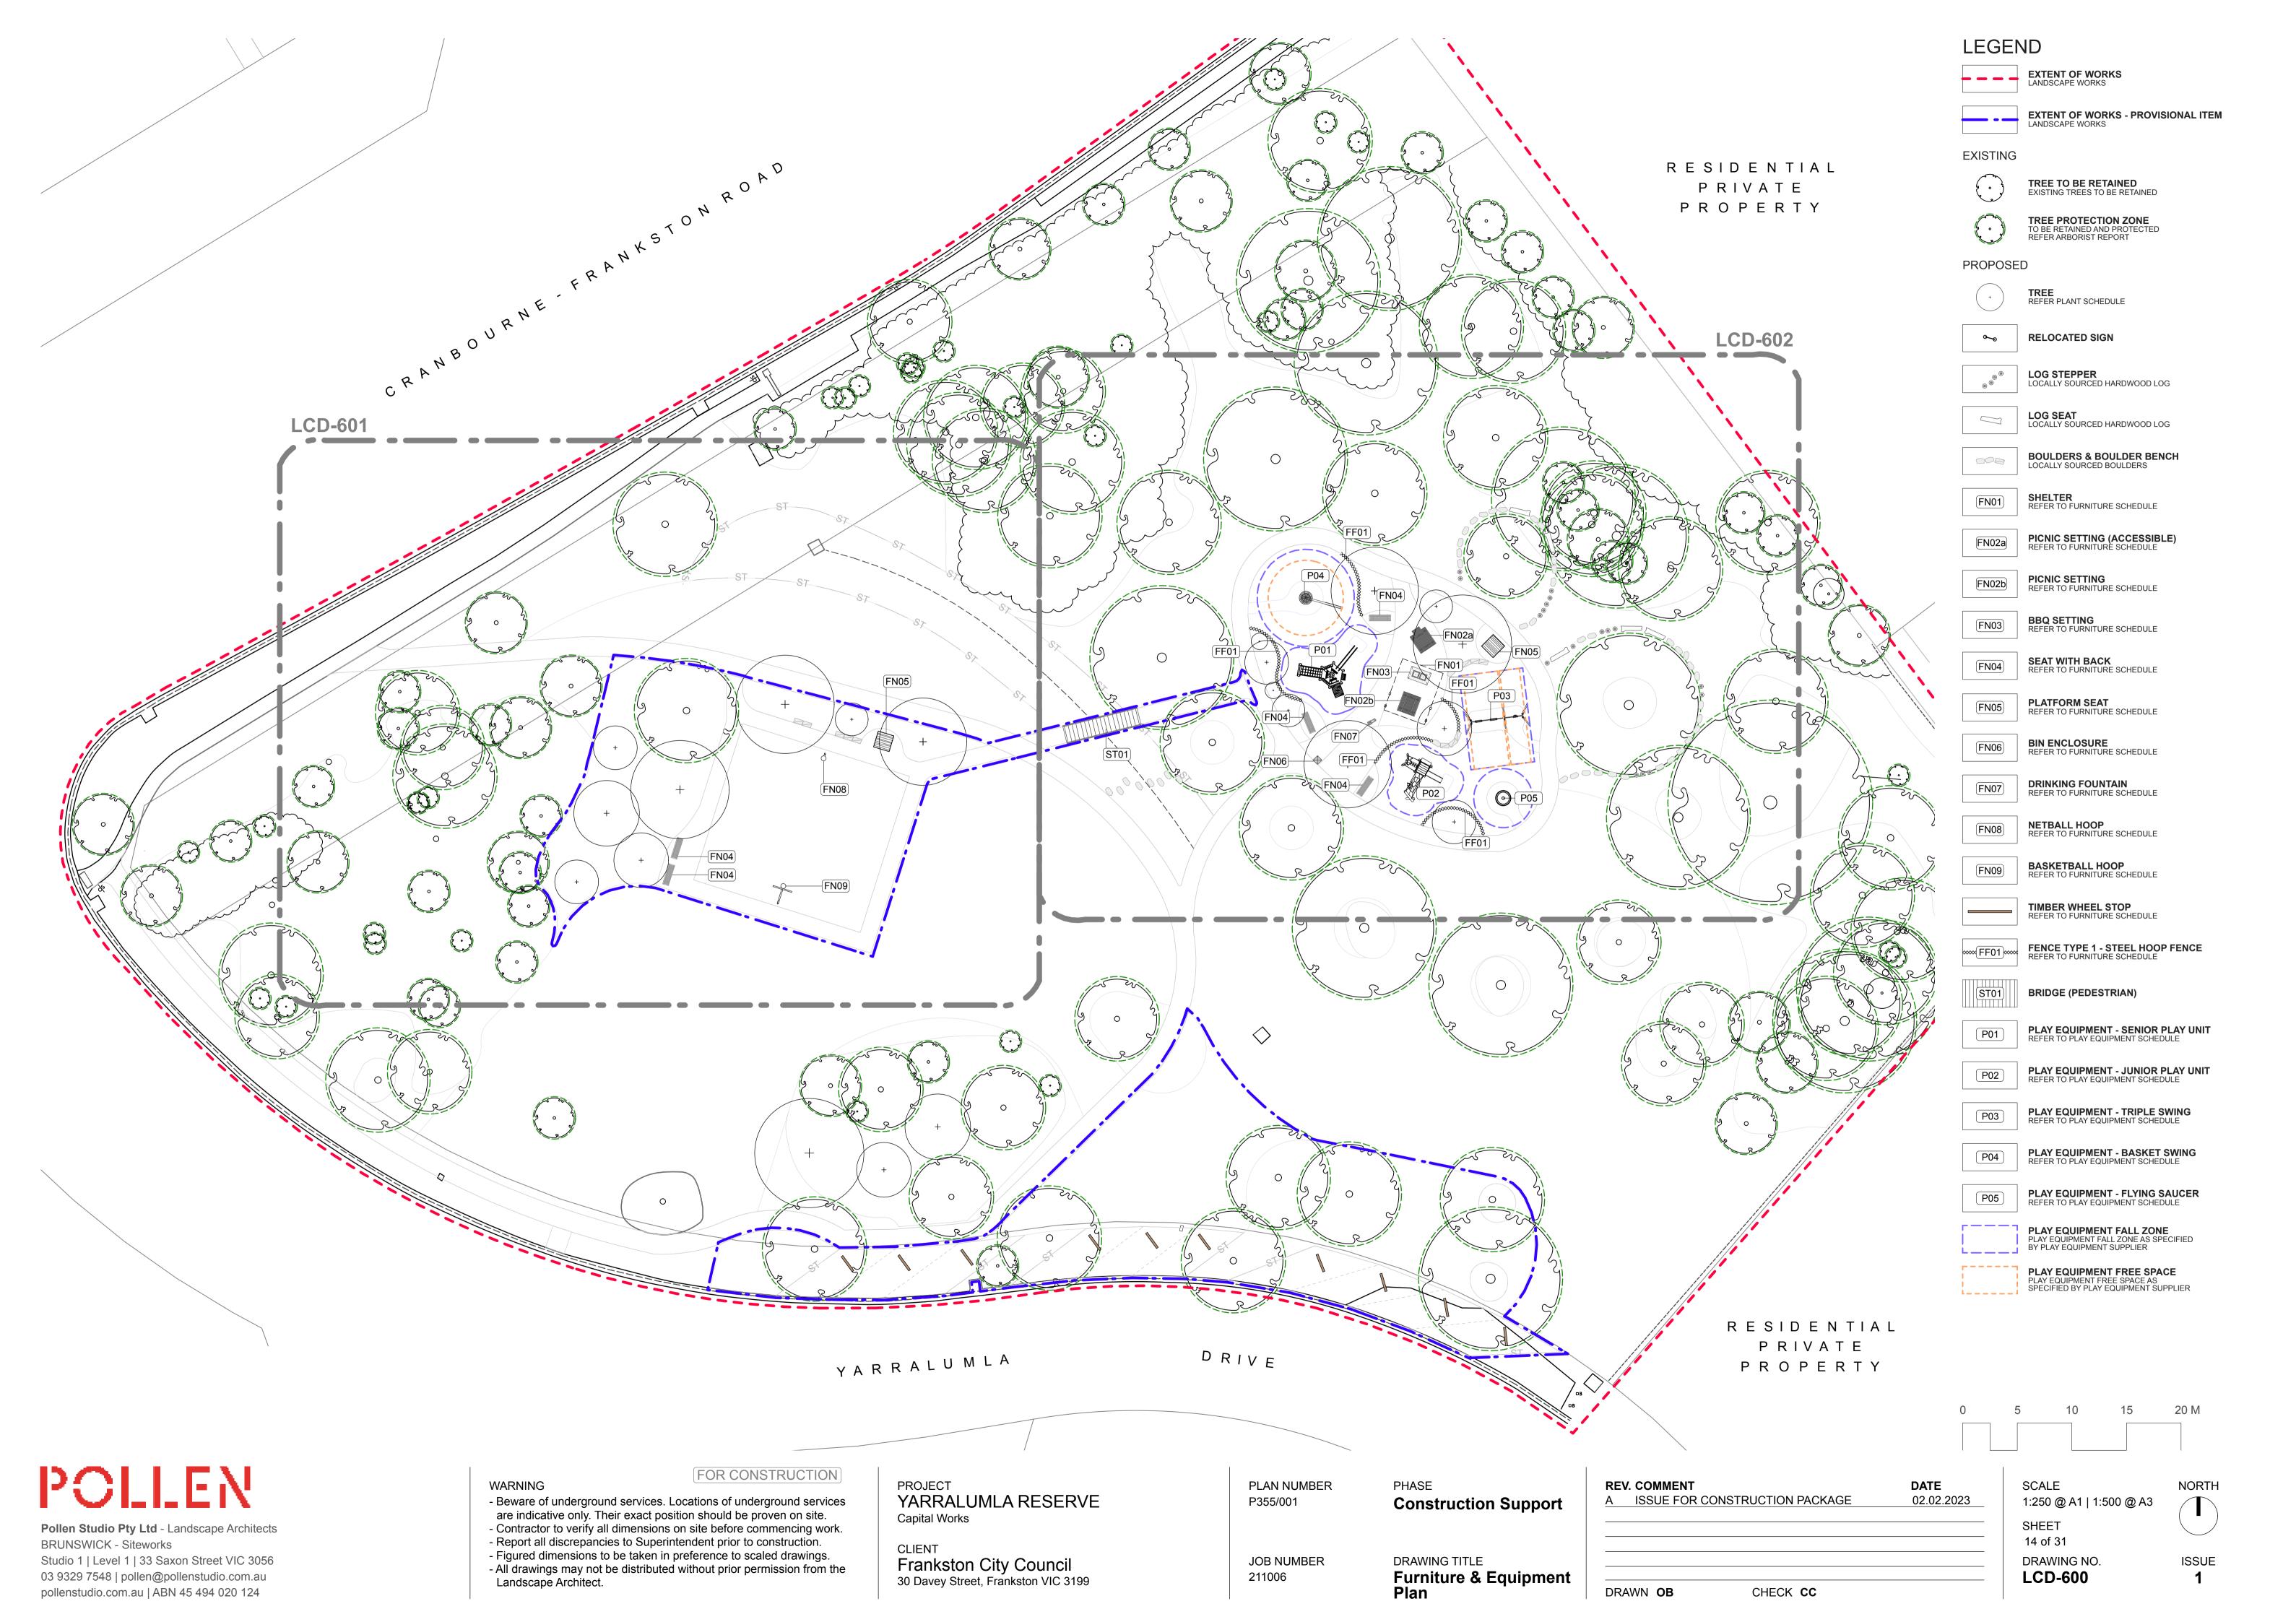


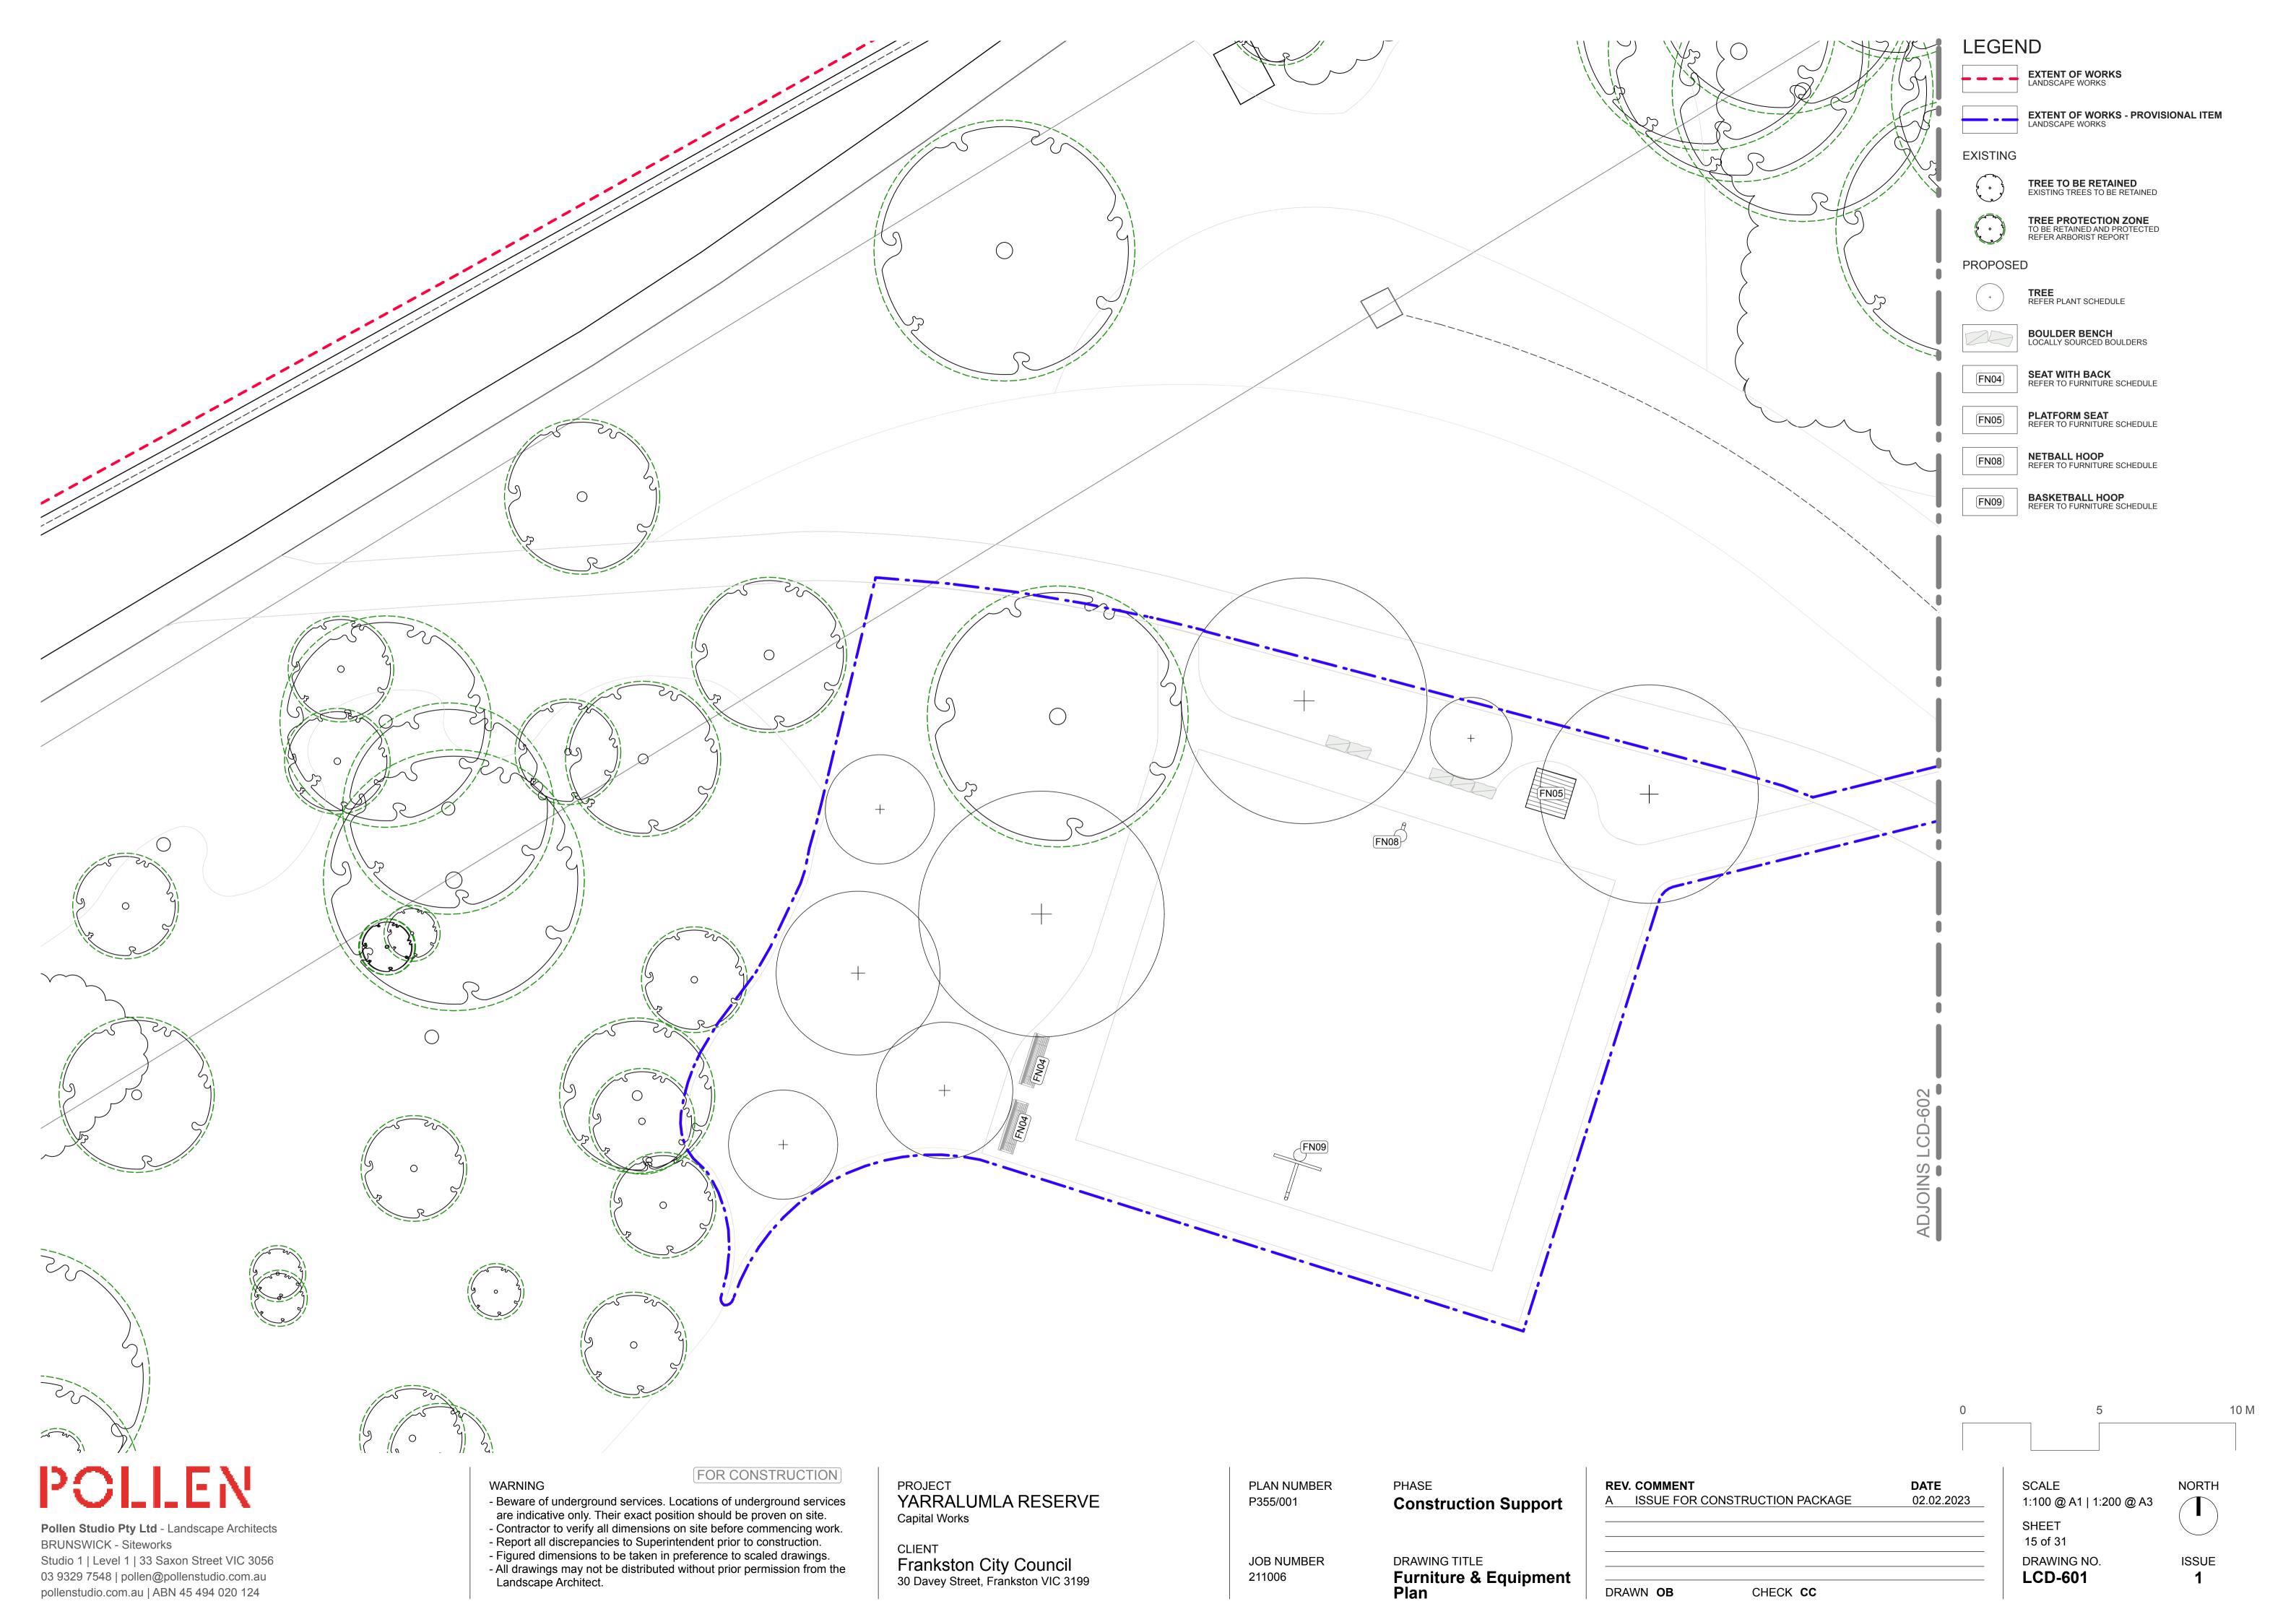

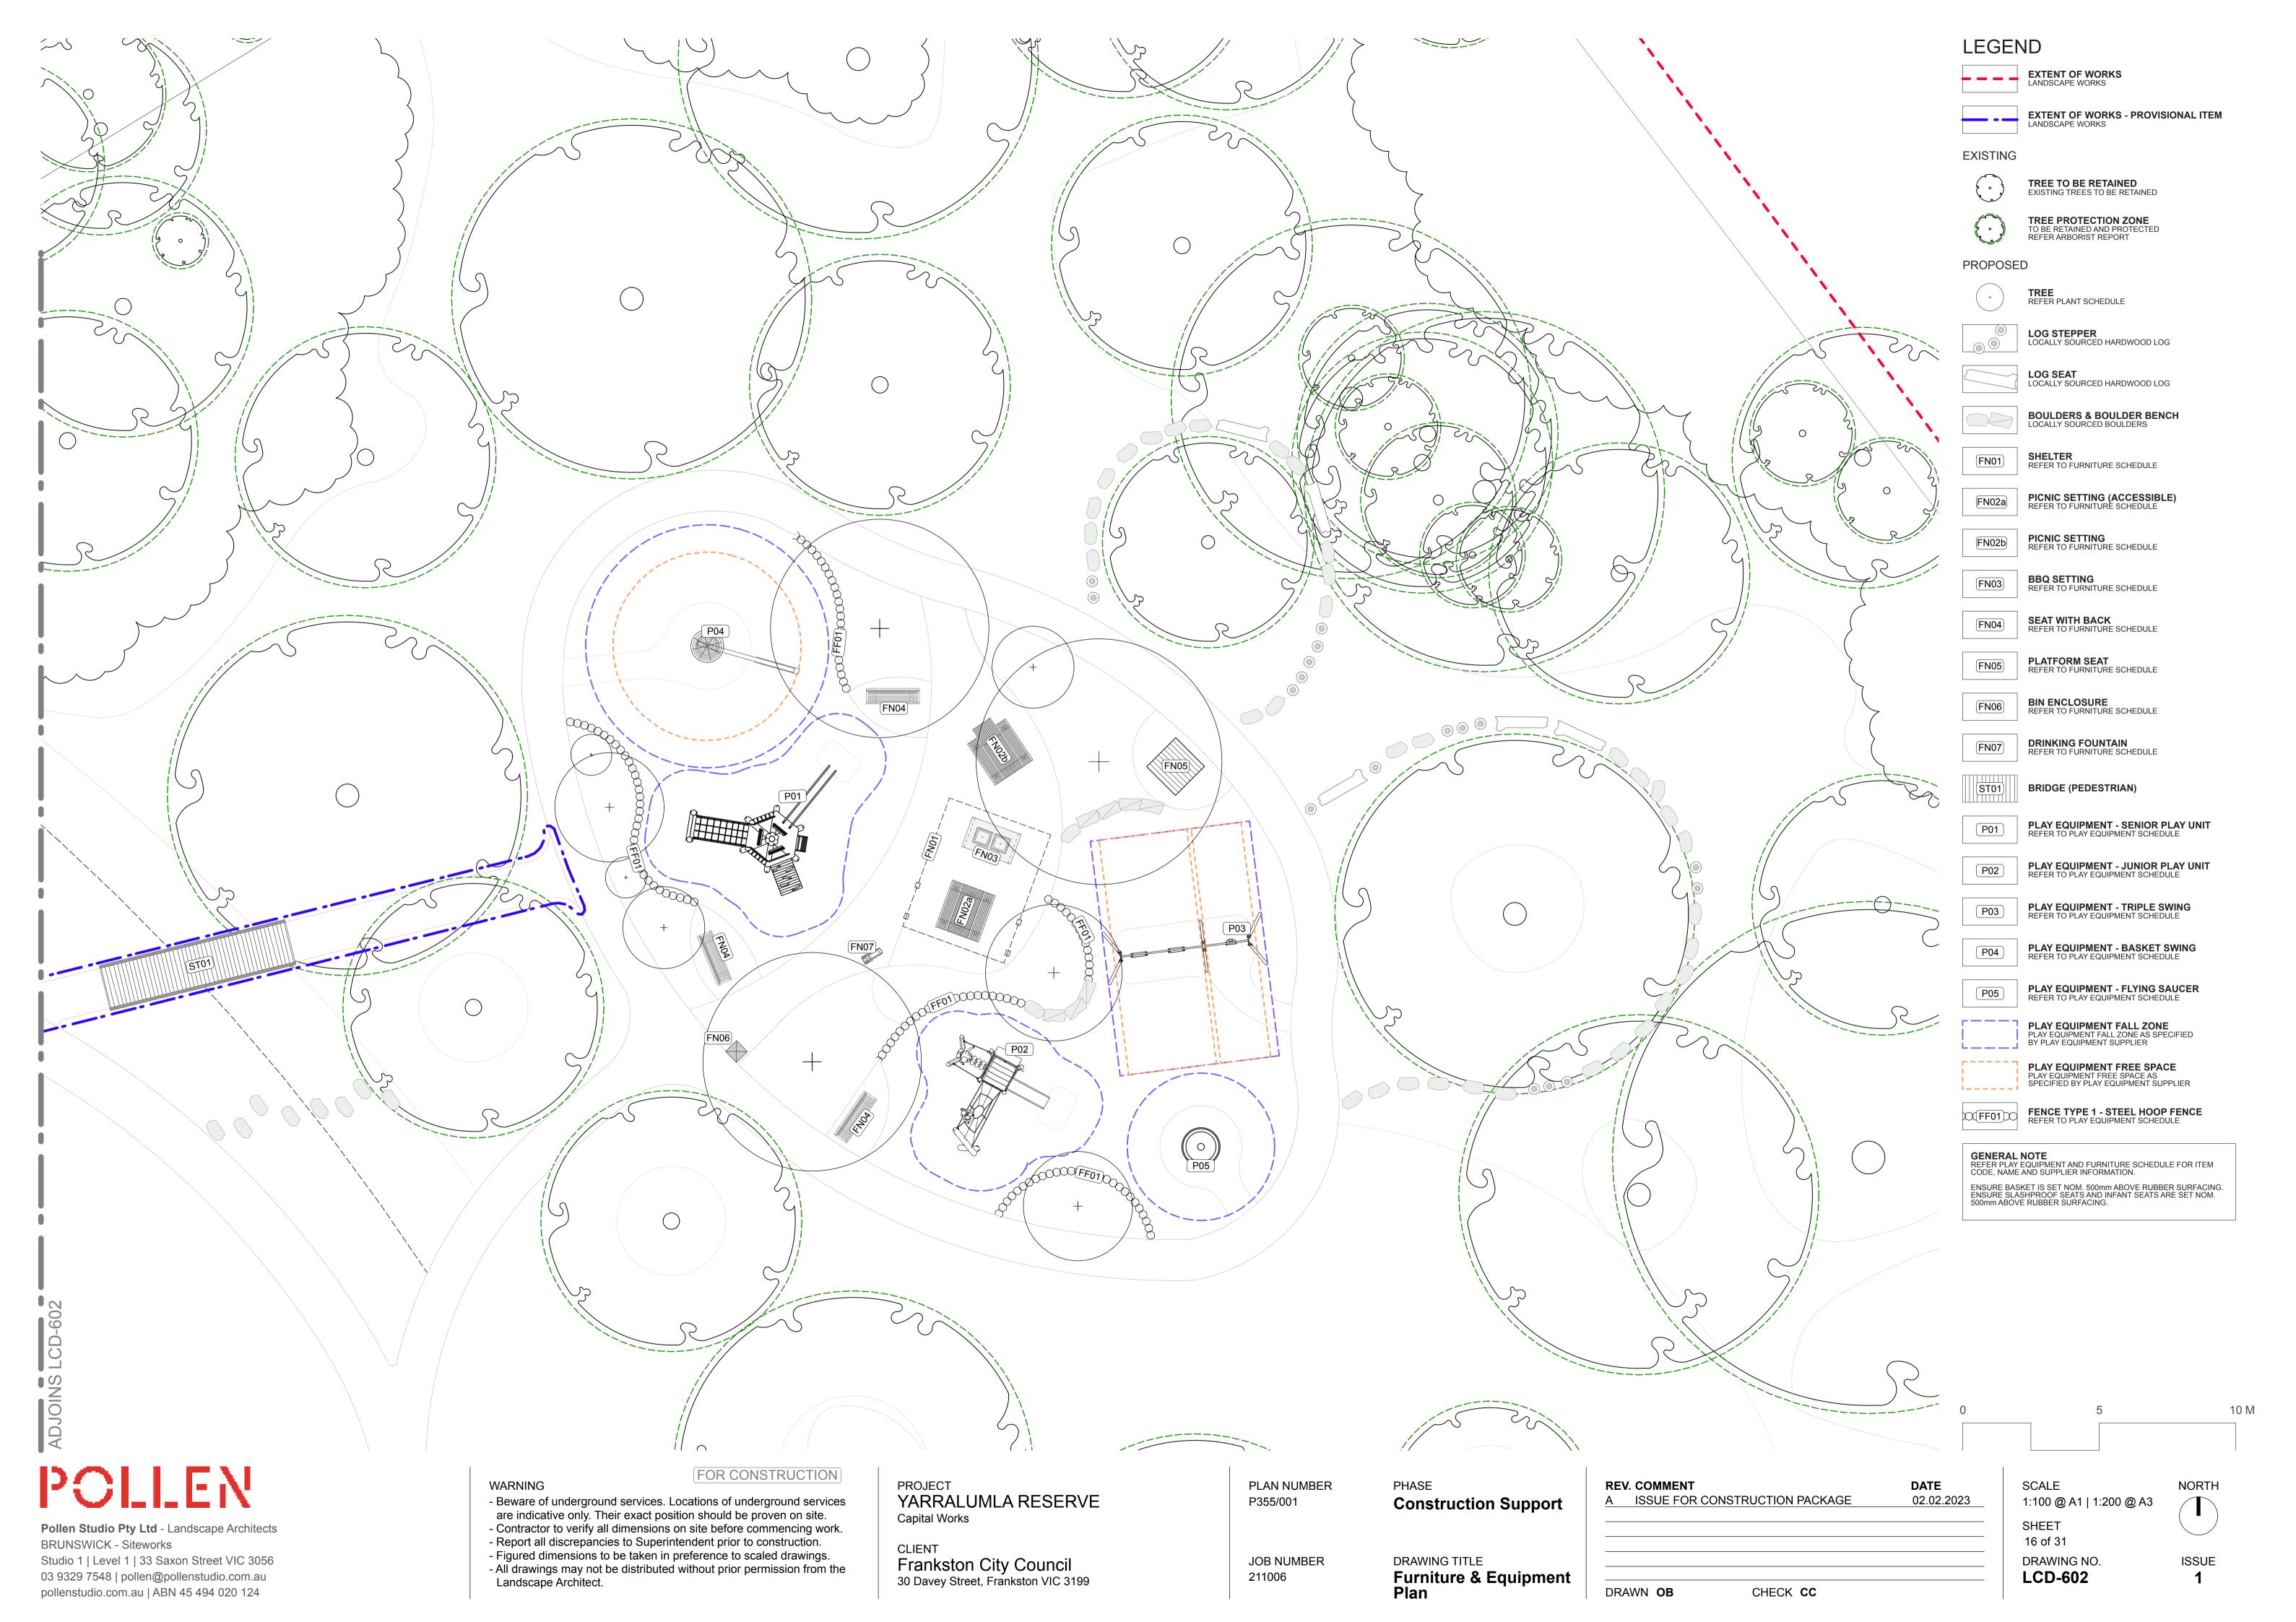

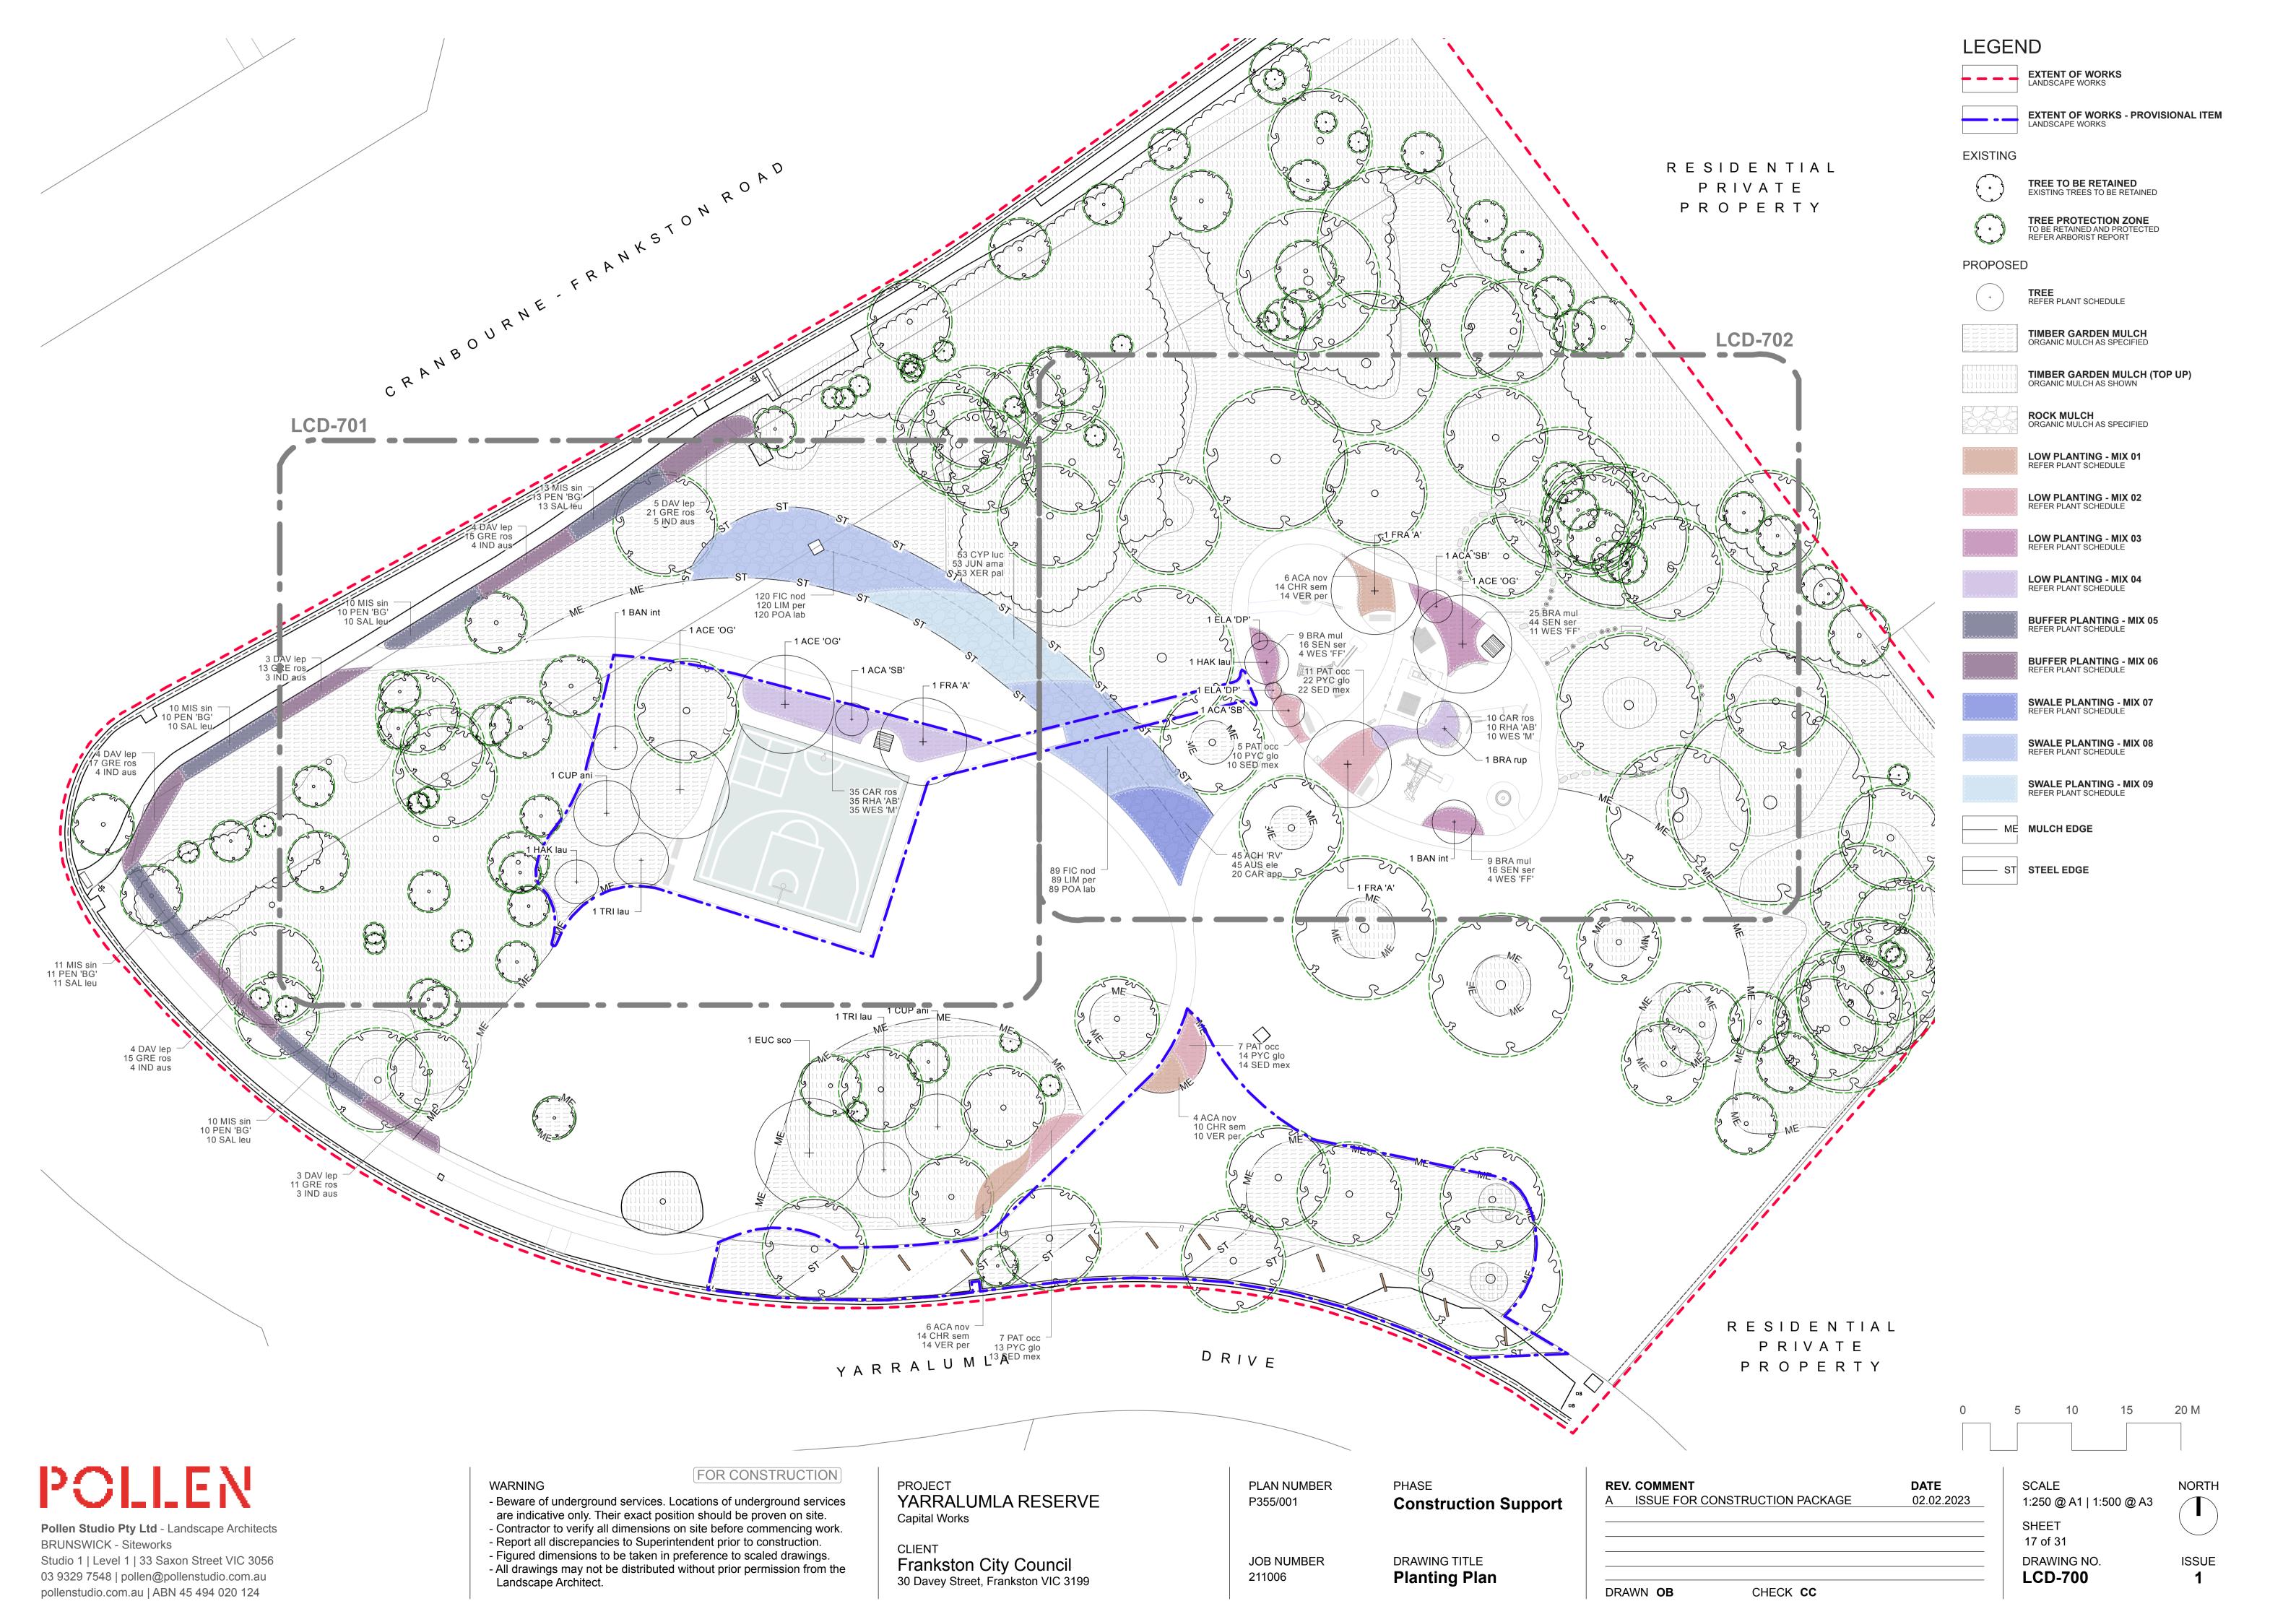

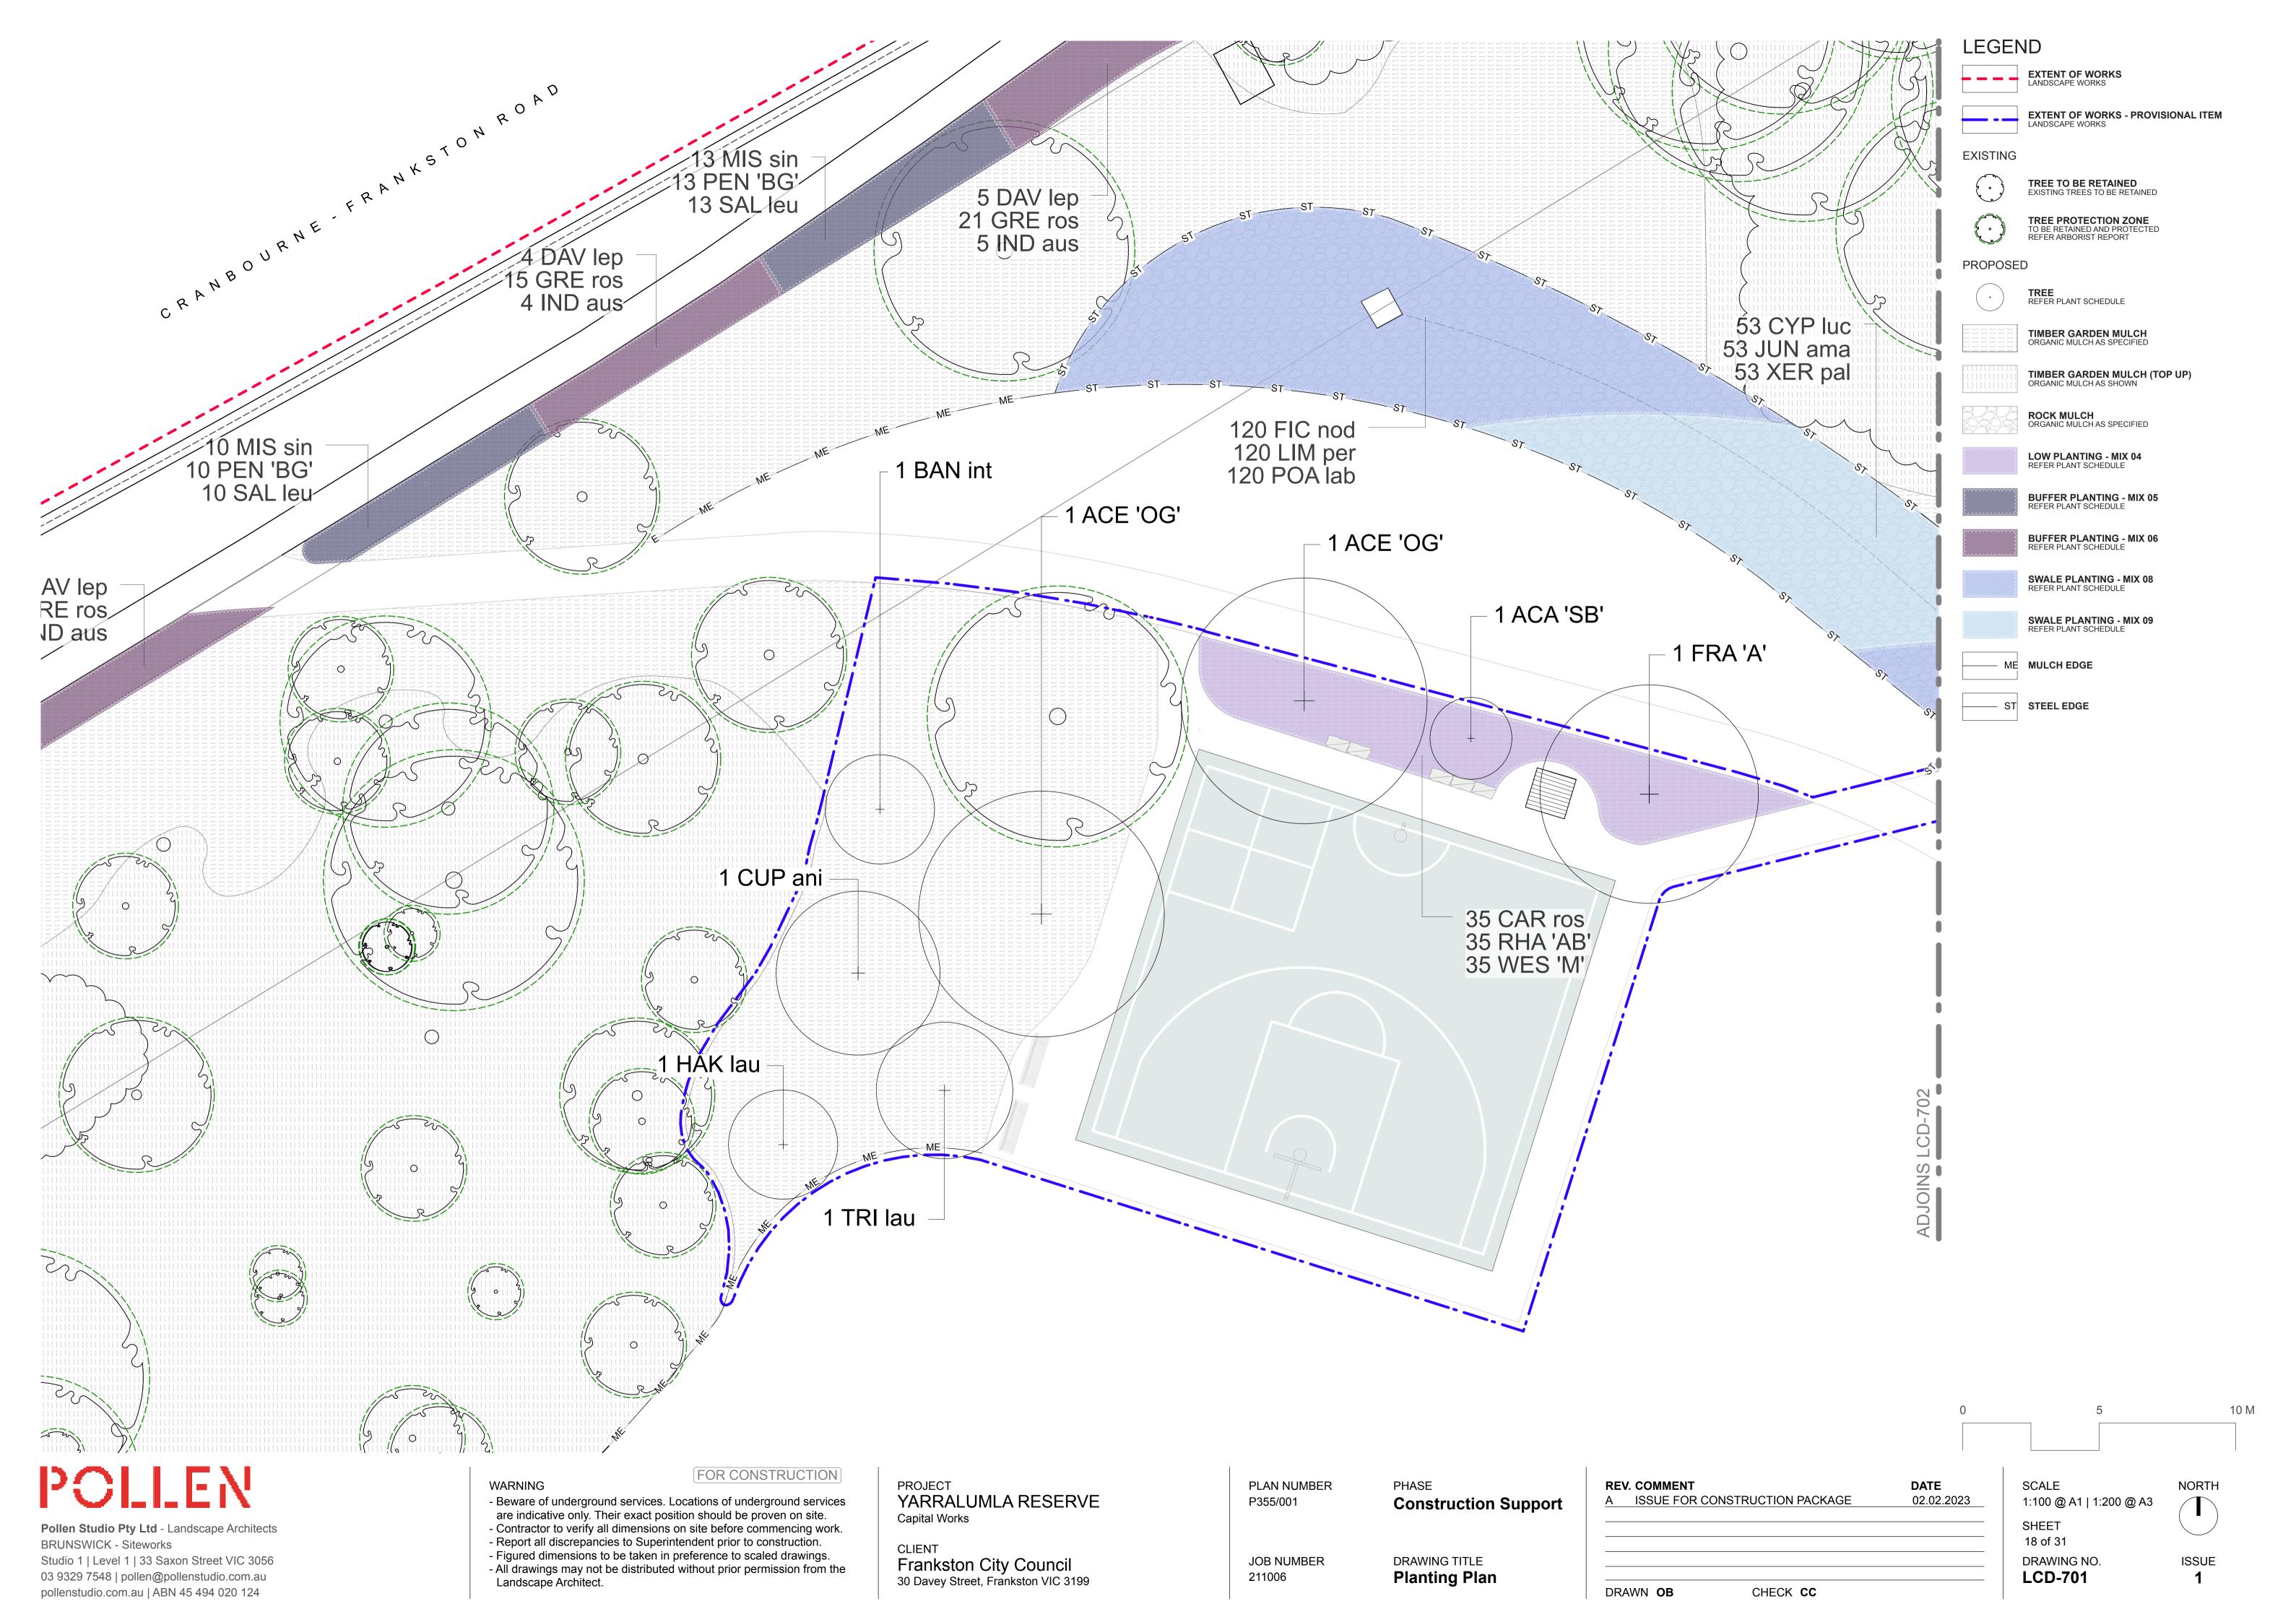

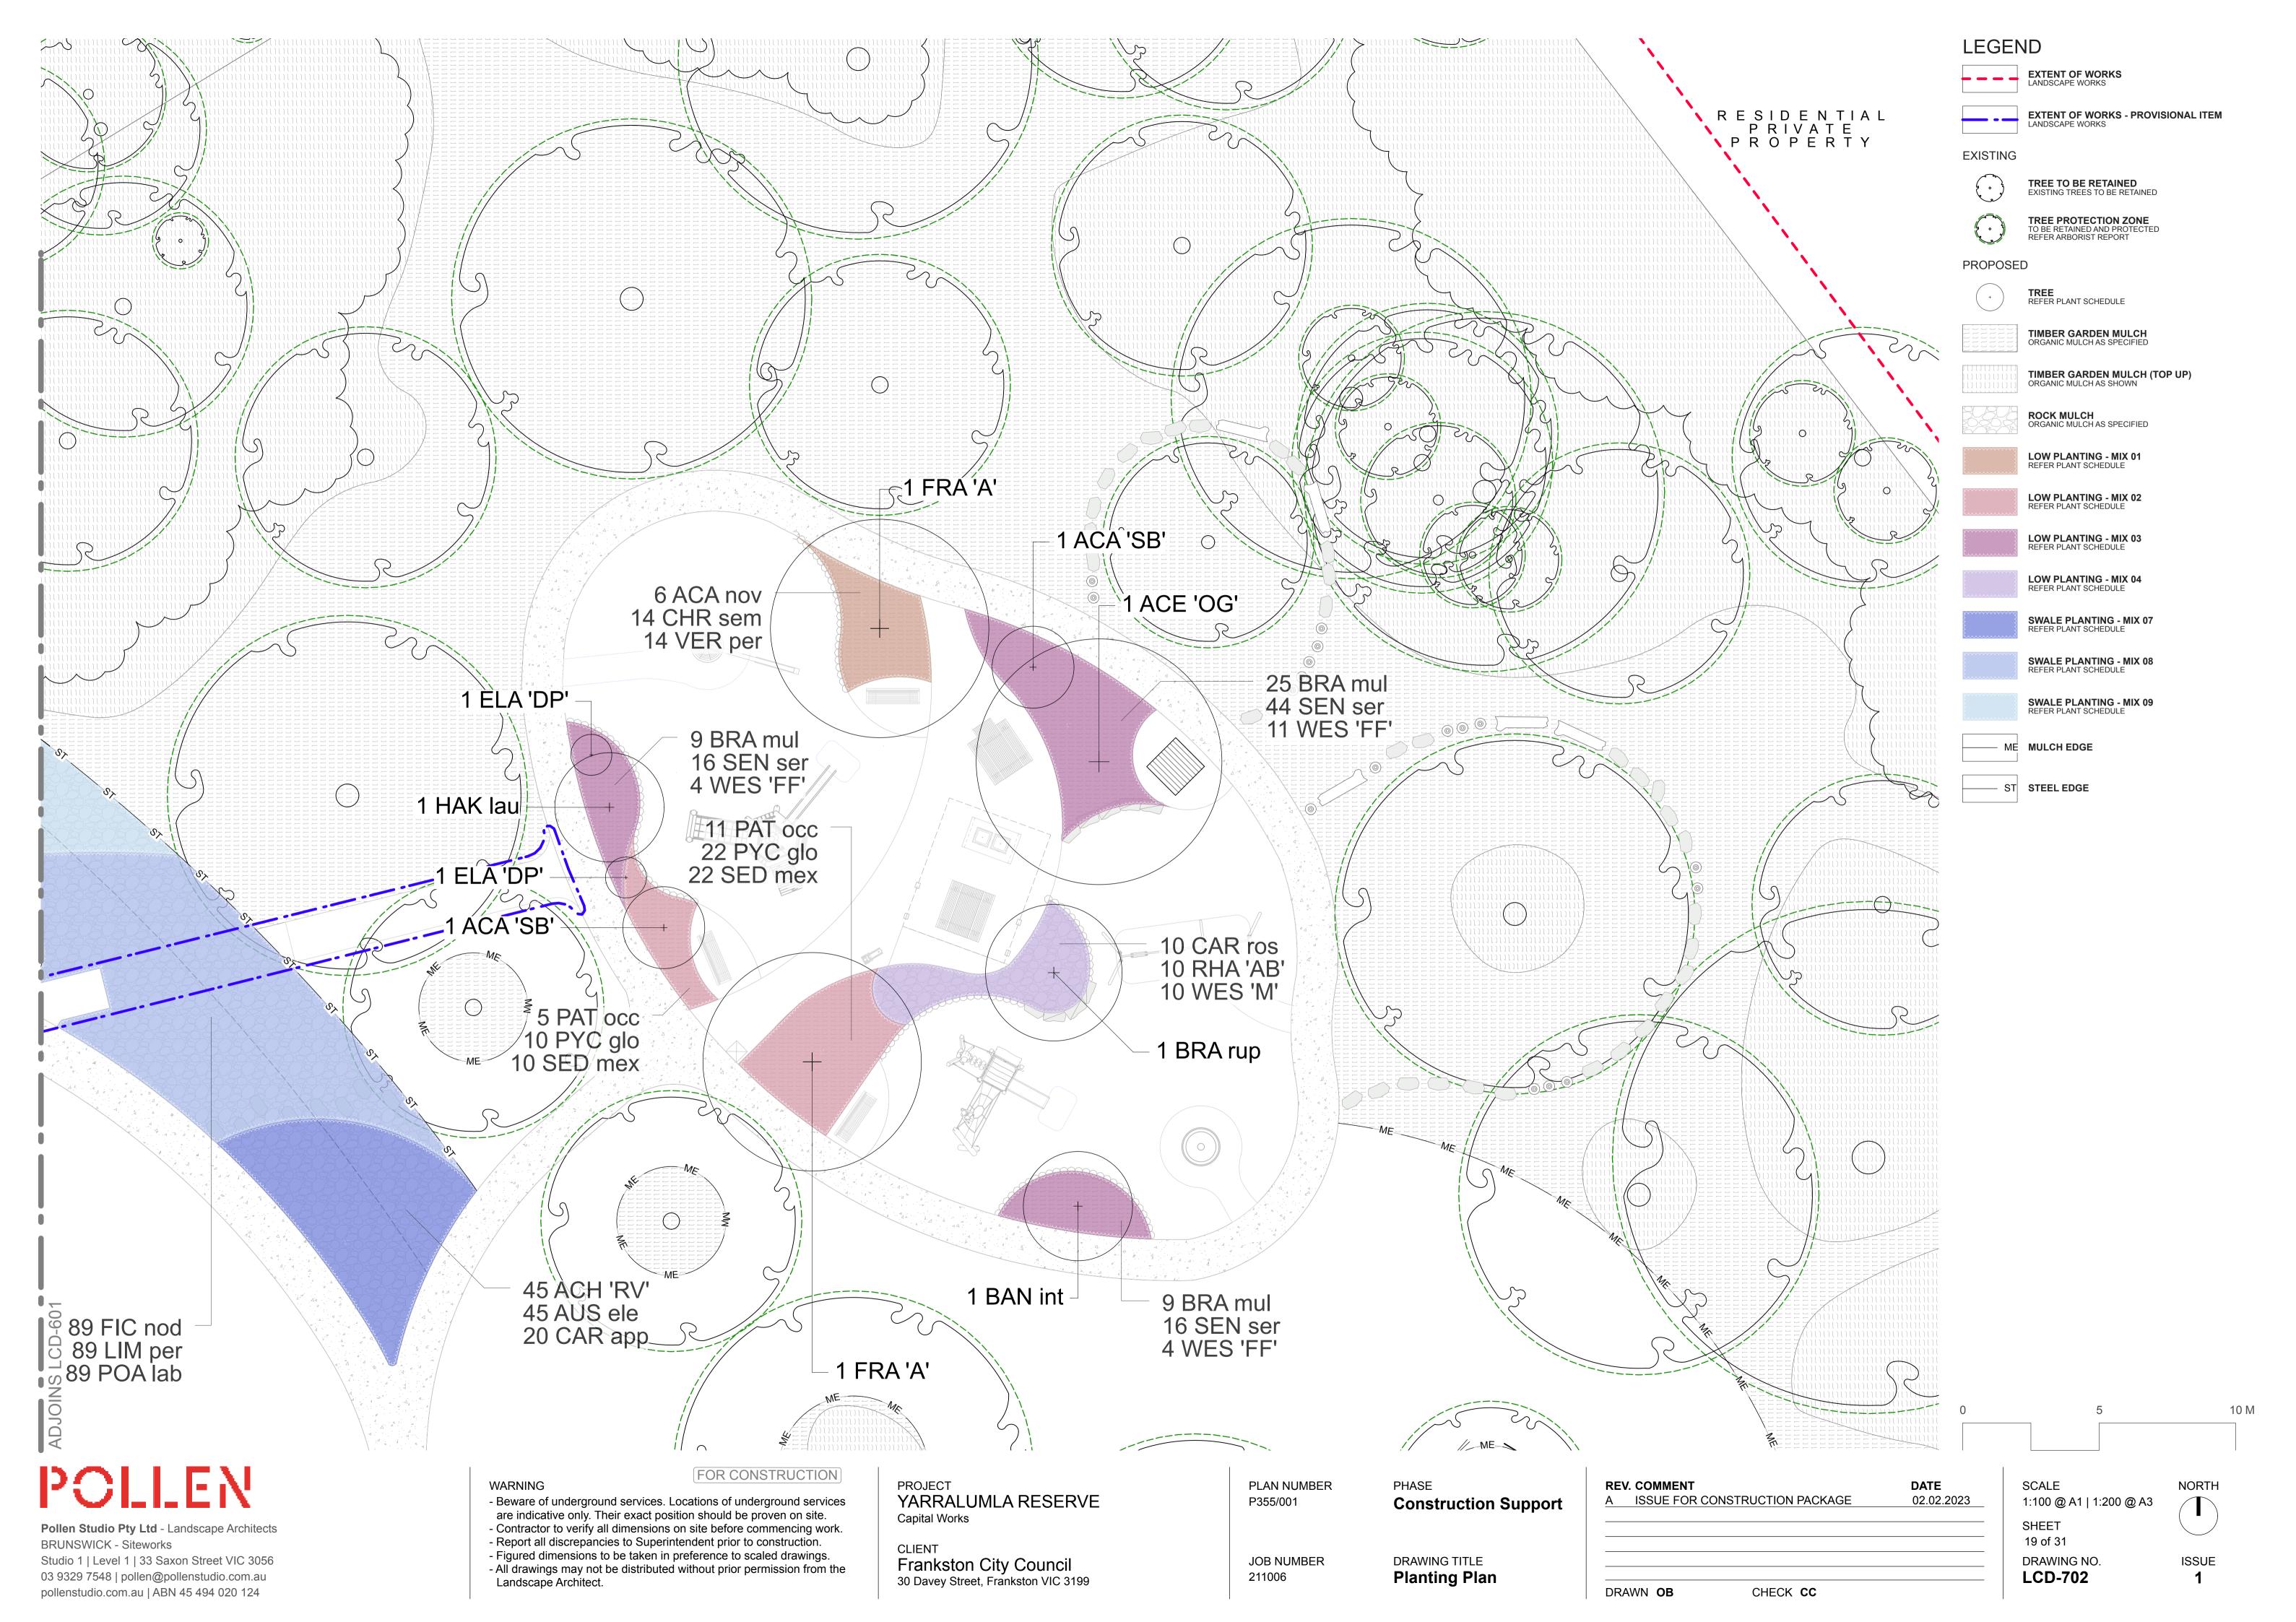

## PLANTING SCHEDULE

CODE	BOTANICAL NAME	COMMON NAME	MATURE H(m) x W(m)	POT SIZE	SPACING	QTY
TREES						
ACA 'SB'	Acacia leprosa 'Scarlet Blaze'	Cinnamon Wattle	5 x 3	45L	as shown	3
ACE 'OG	Acer rubrum 'October Glory'	Lipstick Maple	13 x 9	45L	as shown	3
BAN int	Banksia integrifolia	Coastal Banksia	10 x 4	45L	as shown	2
BRA rup		Bottle Tree	10 x 5	45L	as shown	1
CUP ana	Cupaniopsis anacardioides	Tuckeroo / Carrotwood	7 x 6	45L	as shown	2
ELA 'DP'		Dark Pink Elly	4 x 1.5	45L	as shown	2
EUC sco	Eucalyptus scoparia	Wallangarra White Gum	12 x 10	45L	as shown	1
FRA 'A'	Fraxinus excelsior 'Aurea'	Golden Ash	7 x 8	45L	as shown	3
HAK lau	Hakea laurina	Pincushion Hakea	5 x 4	45L	as shown	2
TRI lau	Tristaniopsis laurina	Kanooka Gum	12 x 4	45L	as shown	2
LOW PLANTII	NG - MIX 01					
ACA nov	Acaena novae-zelandiae	Bidgee Widgee	0.2 x 1	Tubestock	3/m2	12
CHR sem	Chrysocephalum semipapposum	Clustered Everlasting	0.6 x 1	Tubestock	3/m2	28
VER per	Veronica perfoliata	Digger's Speedwell	0.9 x 1.0	Tubestock	3/m2	28
LOW PLANTII	NG - MIX 02					
PAT occ	Patersonia occidentalis	Native Iris	0.6 x 0.5	Tubestock	3/m2	23
PYC glo	Pycnosorus globosus	Billy Buttons	1 x 0.5	Tubestock	3/m2	45
SED mex	Sedum mexicanum	Gold Mound	0.2 x 0.6	Tubestock	3/m2	45
LOW PLANTII	NG - MIX 03					
BRA mul	Brachyscome multifida	Cut Leaf Daisy	0.2 x 0.75	Tubestock	3/m2	43
SEN ser	Senecio serpens	Chalksticks	Creeping	Tubestock	3/m2	76
WES 'FF'	Westringia fruticosa 'Flat n Fruity'	Flat n Fruity	0.2 x 1	Tubestock	2/m2	19
LOW PLANTII	NG - MIX 04	· ·				
CAR ros	Carpobrotus rossii	Pigface / Karkalla	0.2 x 1	Tubestock	2/m2	10
RHA 'AB'	Rhagodia spinescens 'Aussie Flat Bush'	Saltbush	0.4 x 1	Tubestock	2/m2	10
WES 'M'	Westringia fruticosa 'Mundi'	Mundi	0.5 x 1.5	Tubestock	2/m2	10
BUFFER PLA	NTING - MIX 05					
DAV lep	Daviesia leptophylla	Narrow-leaf Bitter Pea	1.5 x 1.5	Tubestock	1/m2	23
GRE ros	Grevillea rosmarinifolia	Rosemary Grevillea	1.5 x 1	Tubestock	2/m2	92
IND aus	Indigofera australis	Austral Indigo	2 x 2	Tubestock	1/m2	23
BUFFER PLA	NTING - MIX 06					
MIS sin	Miscanthus sinensis	Silver Feather Grass	2 x 1	Tubestock	2/m2	54
PEN 'BG'	Pennisetum 'Burgundy Giant'	Burgundy Fountain Grass	1 x 1	Tubestock	2/m2	54
SAL leu	Salvia leucantha	Mexican Bush Sage	0.2 x 1.5	Tubestock	2/m2	54
WSUD PLANT	ING - MIX 07					
ACH 'RV'	Achillea millefolium 'Red Velvet'	Yarrow	0.8 x 0.8	Tubestock	3/m2	45
AUS ele	Austrostipa elegantissima	Tall Feather Grass	1.5 x 0.5	Tubestock	3/m2	45
CAR app	Carex appressa	Tall Sedge	0.5 x 1.5	Tubestock	2/m2	20
WSUD PLANT	ING - MIX 08					
FIC nod	Ficinia nodosa	Knobby Club-rush	0.3 x 0.5-1	Tubestock	3/m2	209
LIM per	Limonium perezii	Sea Lavender	0.6 x 0.6	Tubestock	3/m2	209
· ·	Poa labillardierei	Common Tussock-grass	1.2 x 0.8	Tubestock	3/m2	209
WSUD PLANT	ING - MIX 09					
CYP luc	Cyperus lucidus	Leafy Flat Sedge	1.0 x 1.5	Tubestock	2/m2	53
	Juncus amabilis	Hollow Rush	0.5 x 1	Tubestock	2/m2	53
XER pal	Xerochrysum palustre	Swamp Everlasting	0.5 x 1.0	Tubestock	2/m2	53

45L TOTAL 21 Tubestock TOTAL 1545

**TOTAL** 1566

PLANTING SCHEDULE (MULTI-COURT AREA) CODE BOTANICAL NAME MATURE POT SIZE SPACING QTY COMMON NAME H(m) x W(m) LOW PLANTING - MIX 04 (MULTI-COURT AREA) Pigface / Karkalla Tubestock 2/m2 35 CAR ros Carpobrotus rossii 0.2 x 1 2/m2 RHA 'AB' Rhagodia spinescens 'Aussie Flat Bush' Saltbush 0.4 x 1 Tubestock 35 WES 'M' Westringia fruticosa 'Mundi' 0.5 x 1.5 Tubestock 2/m2 35 Mundi Tubestock TOTAL 105 **TOTAL** 105

CODE BOTANICAL NAME	COMMON NAME	MATURE H(m) x W(m)	POT SIZE	SPACING	QTY
LOW PLANTING - MIX 01 (CAR PARKING AREA)					
ACA nov <i>Acaena novae-zelandiae</i>	Bidgee Widgee	0.2 x 1	Tubestock	3/m2	4
CHR sem <i>Chrysocephalum semipapposum</i>	Clustered Everlasting	0.6 x 1	Tubestock	3/m2	10
VER per Veronica perfoliata	Digger's Speedwell	0.9 x 1.0	Tubestock	3/m2	10
LOW PLANTING - MIX 02 (CAR PARKING AREA)					
PAT occ Patersonia occidentalis	Native Iris	0.6 x 0.5	Tubestock	3/m2	7
PYC glo Pycnosorus globosus	Billy Buttons	1 x 0.5	Tubestock	3/m2	14
SED mex Sedum mexicanum	Gold Mound	0.2 x 0.6	Tubestock	3/m2	14
			Tubes	stock TOTAL	59
				TOTAL	59

POLLEN
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BRUNSWICK - Siteworks
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03 9329 7548   pollen@pollenstudio.com.au

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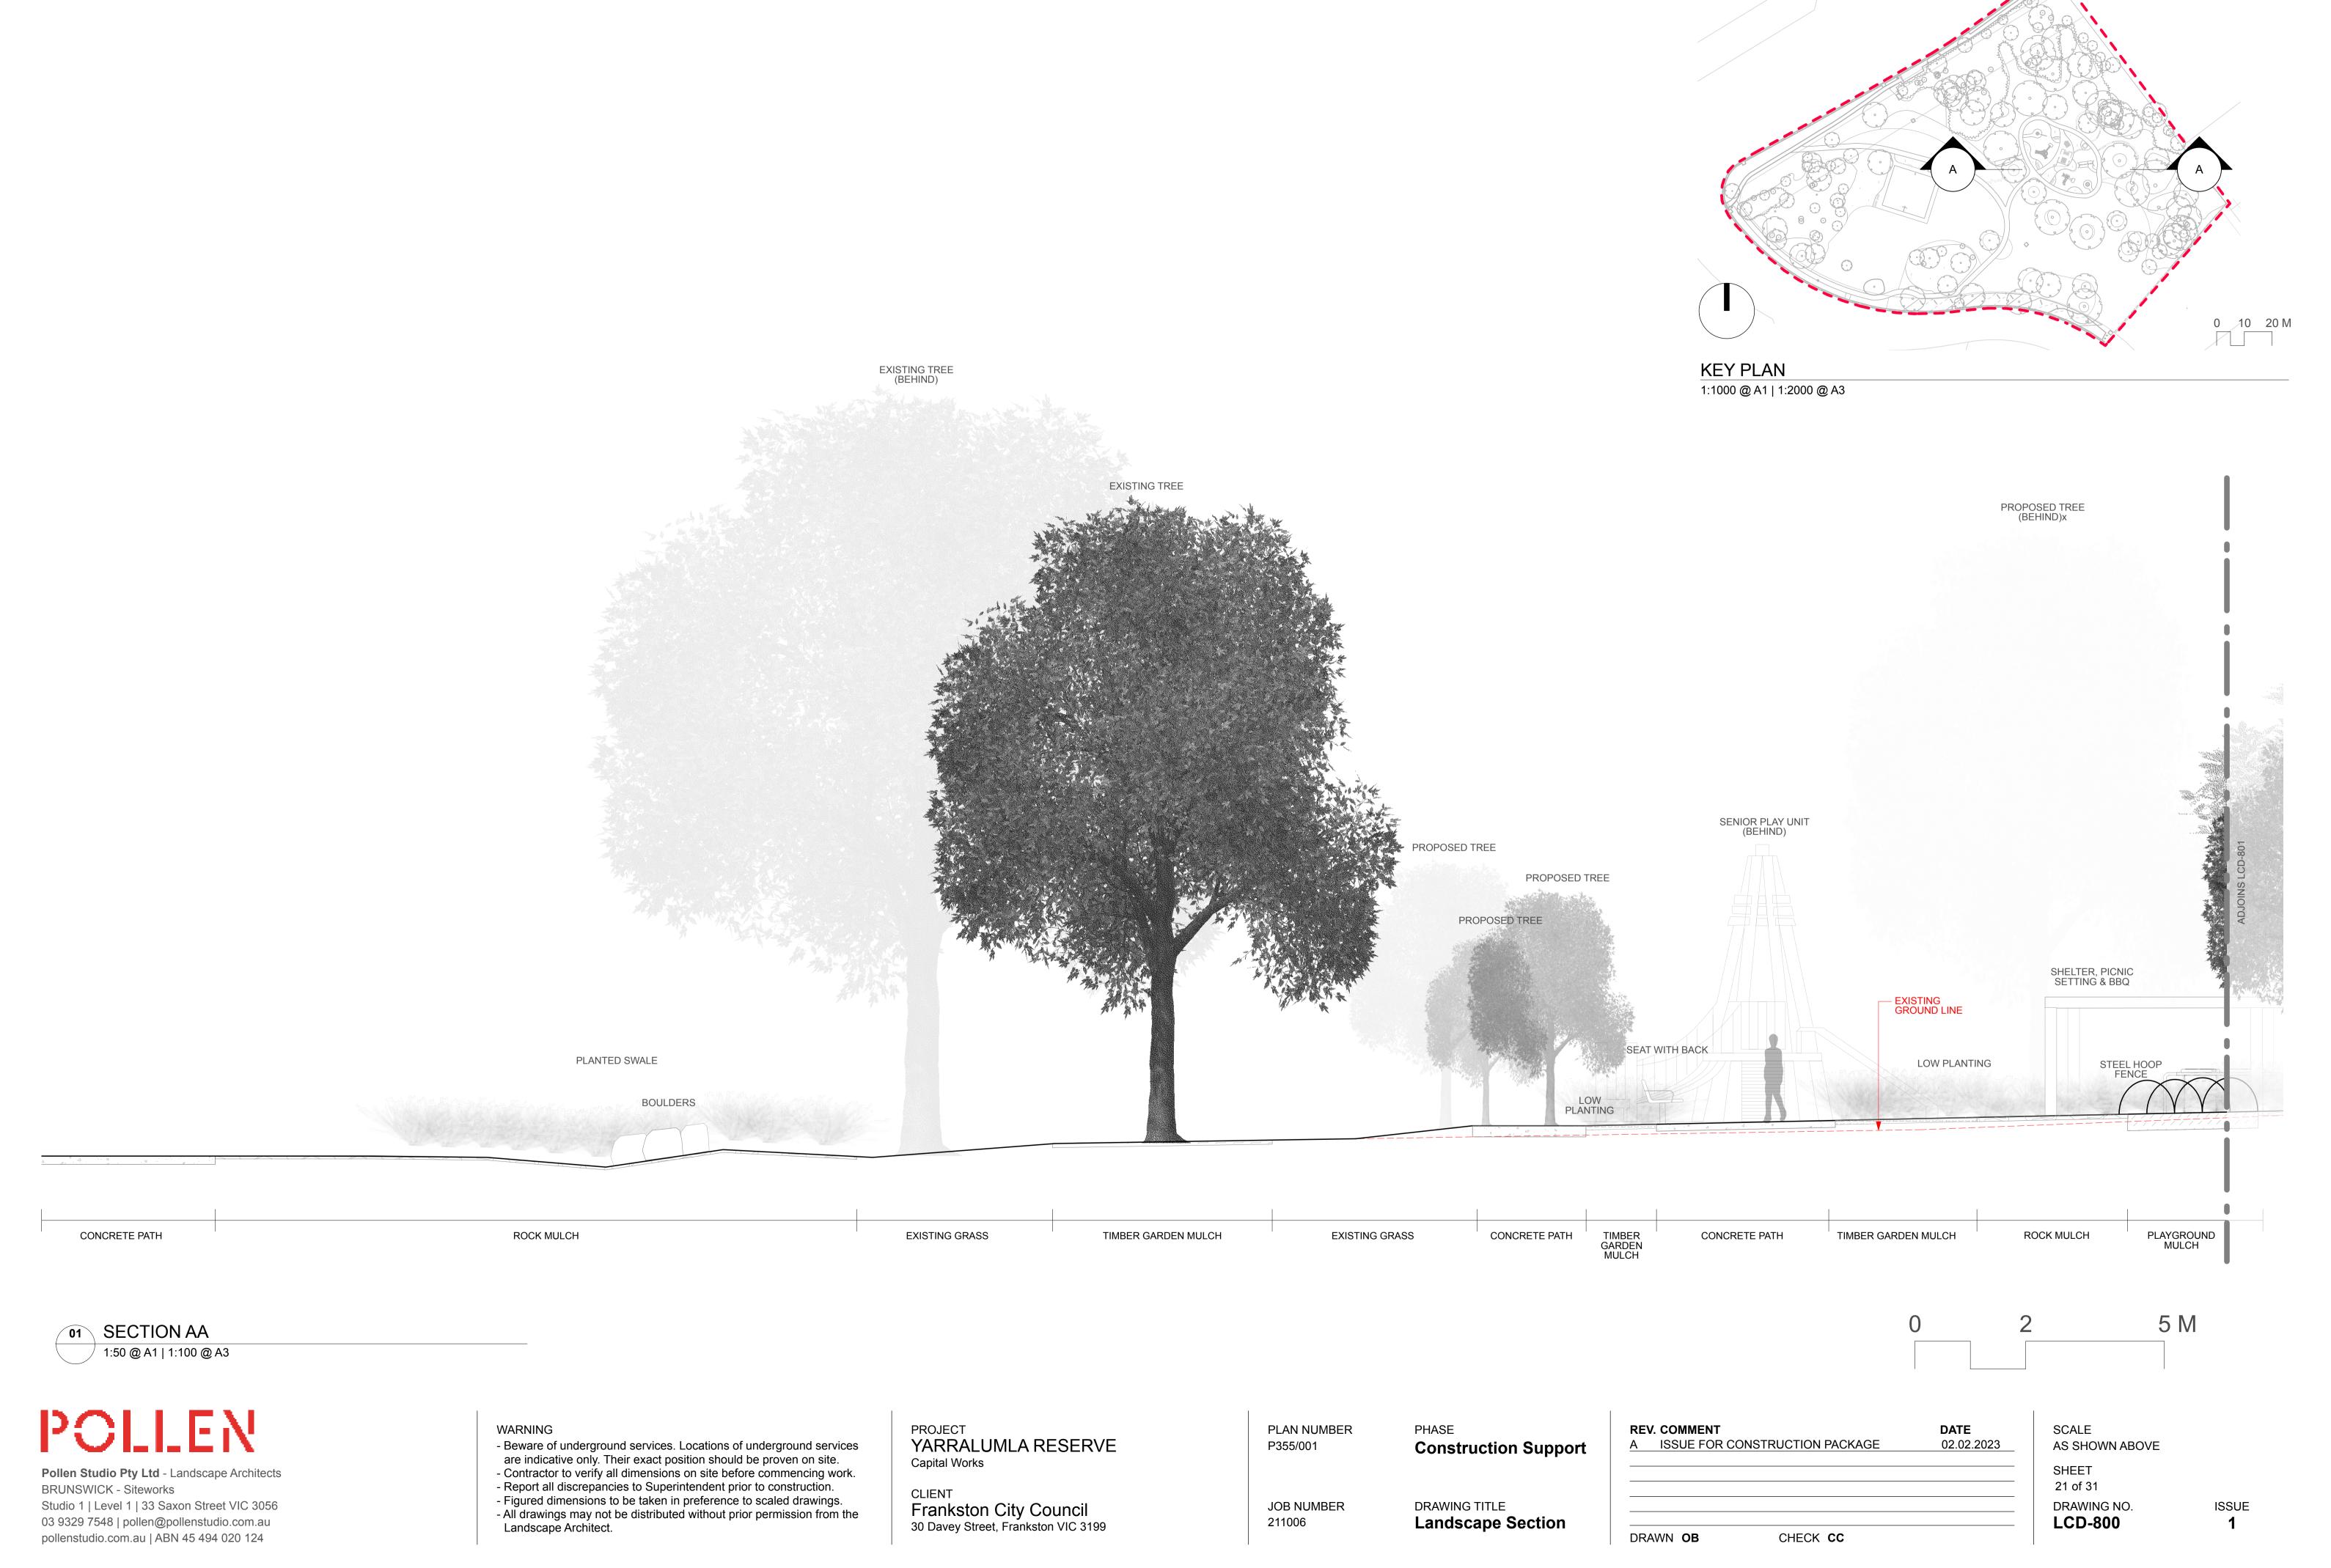
FOR CONSTRUCTION


Beware of underground services. Locations of underground services are indicative only. Their exact position should be proven on site.
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PROJECT YARRALUMLA RESERVE Capital Works

CLIENT Frankston City Council
30 Davey Street, Frankston VIC 3199

PLAN NUMBER P355/001	PHASE  Construction Support	REV. COMMENT A ISSUE FOR CONSTRUCTION PACKAGE	<b>DATE</b> 02.02.2023
JOB NUMBER 211006	DRAWING TITLE Planting Schedule	DRAWN <b>OB</b> CHECK <b>CC</b>	





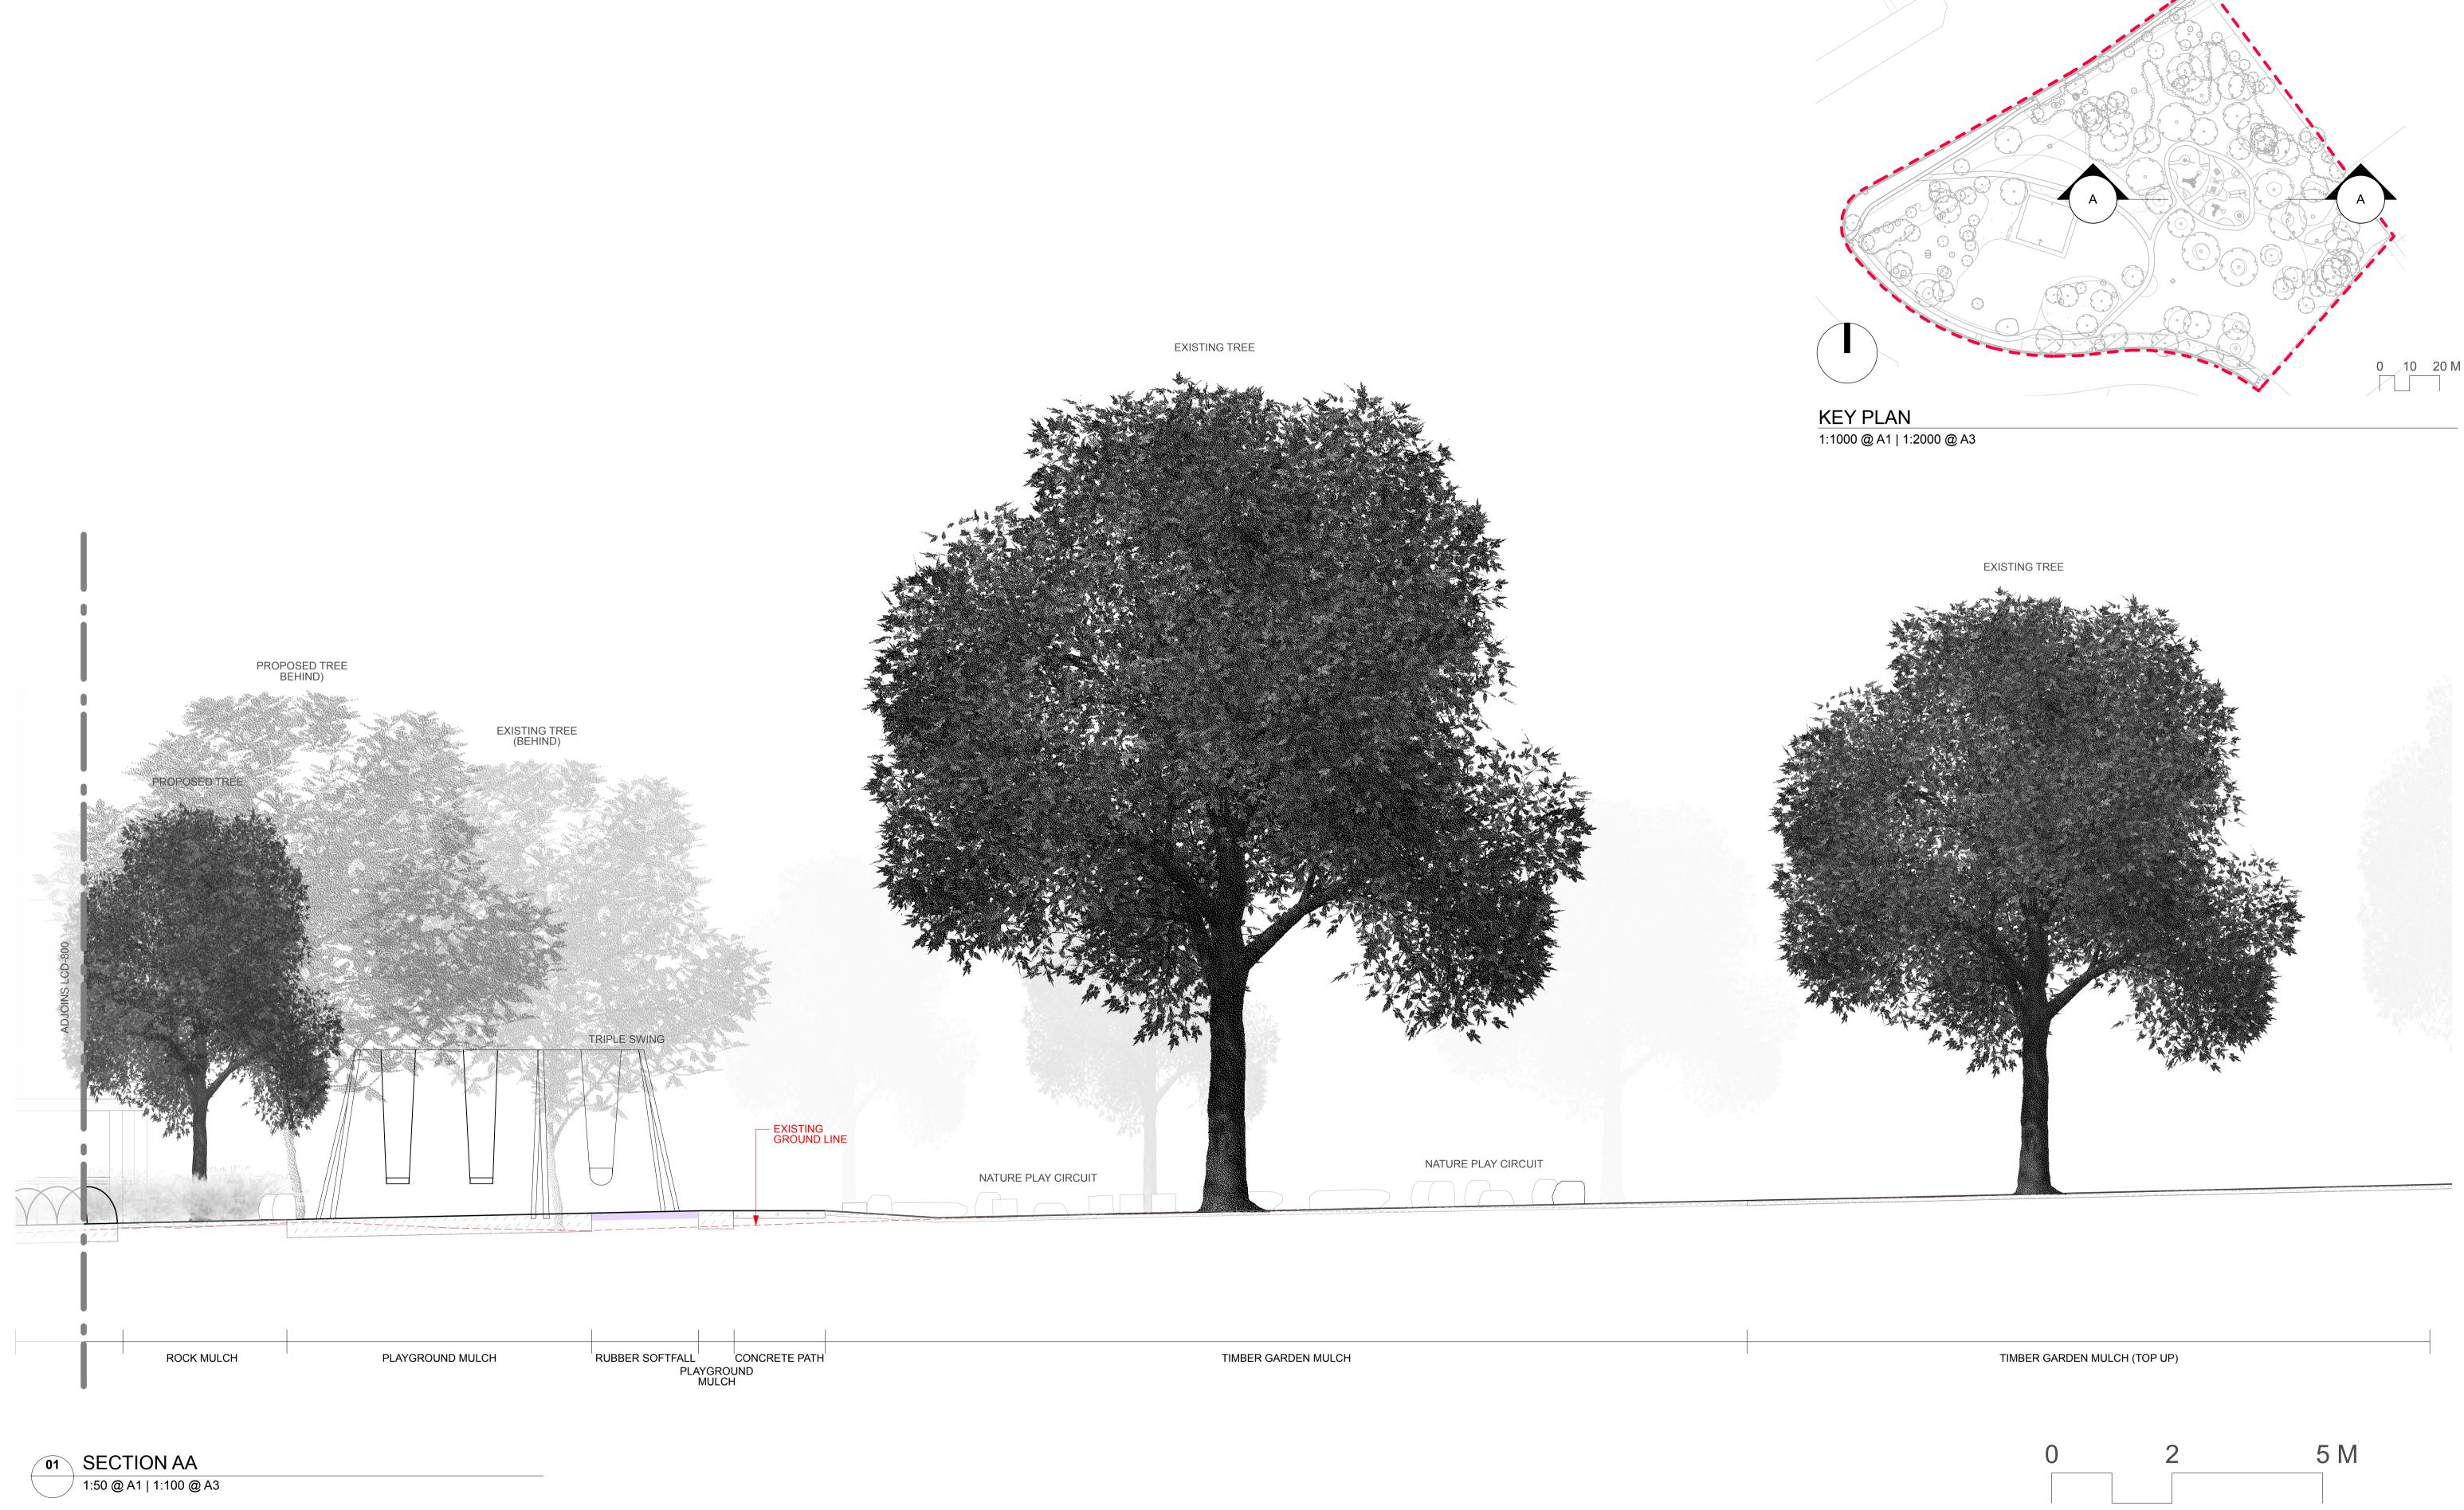

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PROJECT YARRALUMLA RESERVE Capital Works

Frankston City Council
30 Davey Street, Frankston VIC 3199

PLAN NUMBER P355/001

JOB NUMBER

211006

**Construction Support** 

DRAWING TITLE **Landscape Section** 


DRAWN **OB** 


DATE **REV. COMMENT** 02.02.2023 A ISSUE FOR CONSTRUCTION PACKAGE

CHECK CC

SCALE AS SHOWN ABOVE SHEET 22 of 31

DRAWING NO. LCD-801

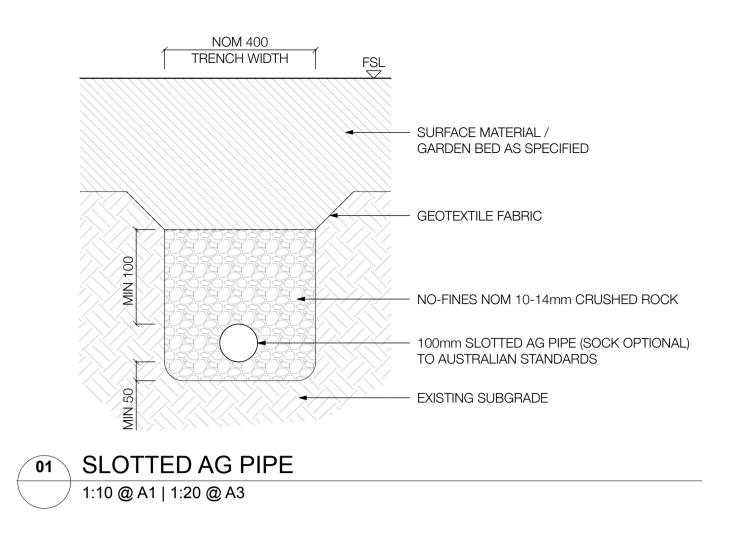


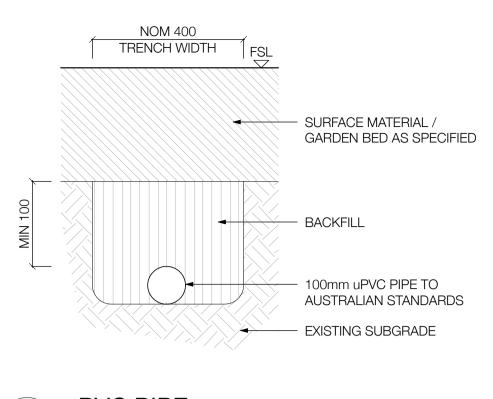

TIMBER PLAYGROUND MULCH DETAIL


30 Davey Street, Frankston VIC 3199

02 uPVC PIPE 1:10 @ A1 | 1:20 @ A3

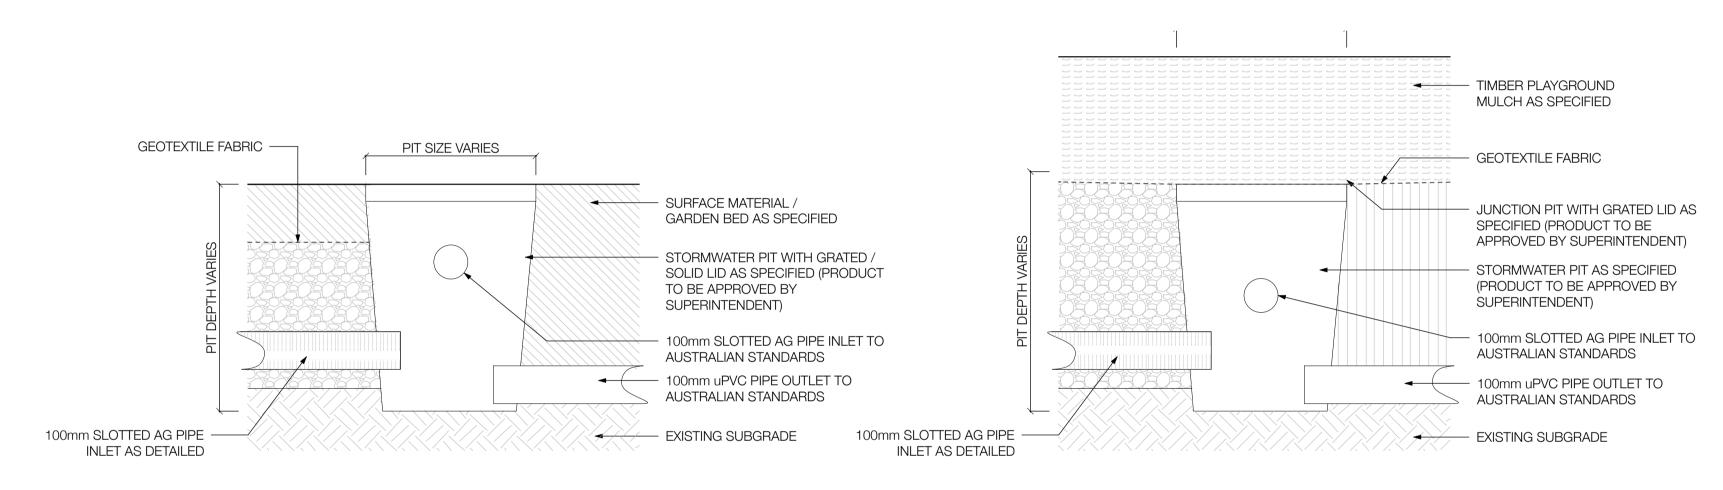

ALL STORMWATER PITS TO BE DETERMINED AND CONFIRMED ONSITE WITH SOIL INFILTRATION RATE. ENSURE ALL WORKS ARE IN ACCORDANCE WITH AUSTRALIAN STANDARDS. PIT SIZE AND DEPTH TO BE DETERMINED IN ACCORDANCE WITH THE PLUMBING CODE AS3500.3 - REFER TO TABLE 7.5.2.1: MINIMUM INTERVAL DIMENSIONS FOR STOMRWATER AND INLET PITS


DEPTH TO INVERT OF OUTLET	MINIMUM INTERNAL DIMENSION mm			
	RECTANGULAR		CIRCULAR	
	WIDTH	LENGTH	DIAMETER	
≤450	350	350	-	
<600	450	450	600	
>600 ≤900	600	600	900	
>900 ≤ 1200	600	900	1000	
>1200	900	900	1000	

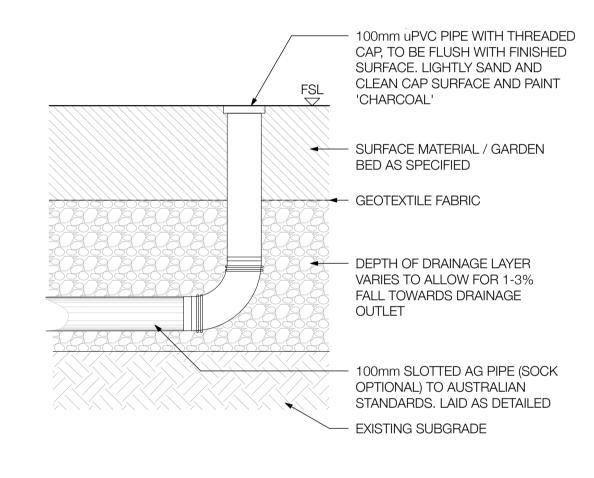


04 INSPECTION OPENING (IO) 1:10 @ A1 | 1:20 @ A3


## DRAINAGE PIT (GP1) 1:10 @ A1 | 1:20 @ A3

TYPICAL DETAIL

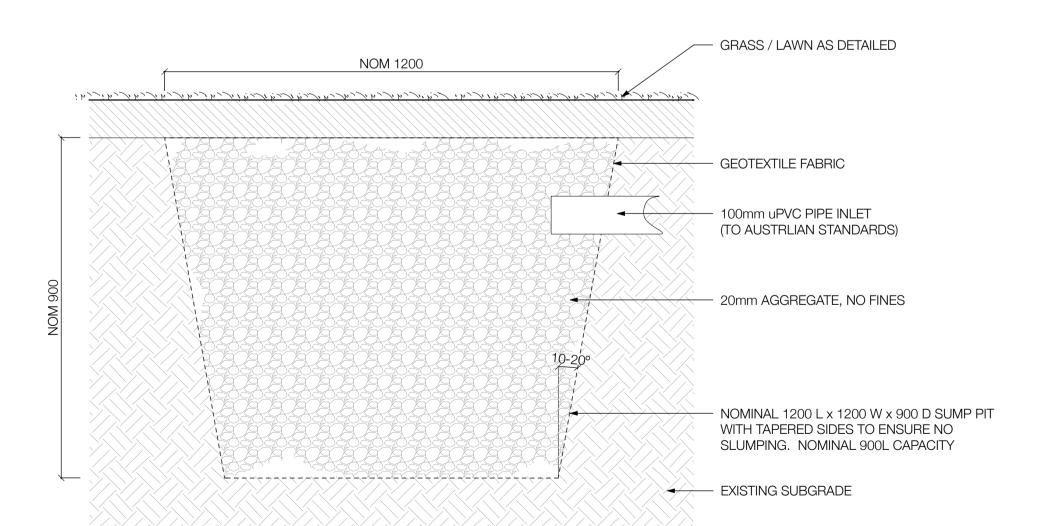

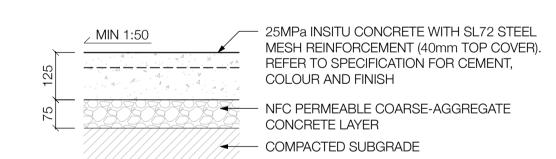


#### NO-DIG / PAVING WITHIN TPZ DETAIL

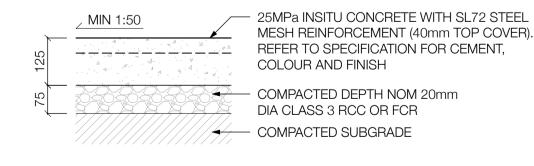



DRAWN **OB** 

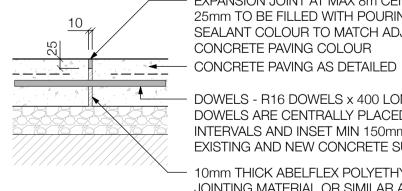

EXPANSION JOINT AT MAX 8m CENTRES. TOP 25mm TO BE FILLED WITH POURING GRADE SEALANT COLOUR TO MATCH ADJACENT INSITU CONCRETE PAVING COLOUR

DOWELS - R16 DOWELS x 400 LONG. ENSURE DOWELS ARE CENTRALLY PLACED AT 300mm INTERVALS AND INSET MIN 150mm INTO EXISTING AND NEW CONCRETE SURFACE

10mm THICK ABELFLEX POLYETHYLENE FOAM JOINTING MATERIAL OR SIMILAR APPROVED

TYPICAL DETAIL SAW CUT DETAIL **EXPANSION JOINT DETAIL** 

Landscape Details

SUMP PIT (900L) 1:10 @ A1 | 1:20 @ A3

TYPICAL DETAIL

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FOR CONSTRUCTION

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CONCRETE PAVING - TYPE 1 & 2 (SF01 & SF02) 1:10 @ A1 | 1:20 @ A3

**PROJECT** PLAN NUMBER PHASE YARRALUMLA RESERVE P355/001 **Construction Support** Capital Works **CLIENT** JOB NUMBER DRAWING TITLE Frankston City Council


211006

**REV. COMMENT** DATE ISSUE FOR CONSTRUCTION PACKAGE 02.02.2023


CHECK CC

SCALE AS SHOWN ABOVE SHEET

23 of 31 DRAWING NO. LCD-900

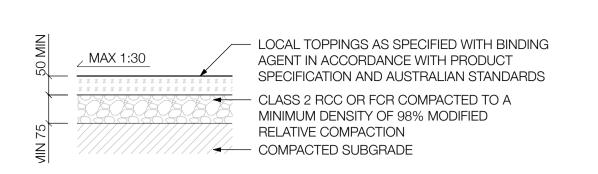


NOTE BASE COURSE. THE THICKNESS OF FINE CRUSHED ROCK SUB BASE SHALL DECREASE TO 50mm WITHIN A 5 METRE RADIUS OF TREES

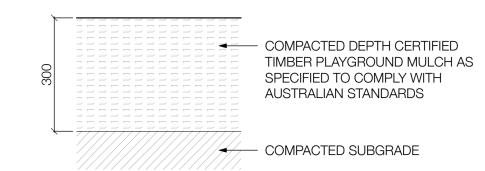




CERTIFIED PLAYGROUND MULCH (SF04) 1:10 @ A1 | 1:20 @ A3

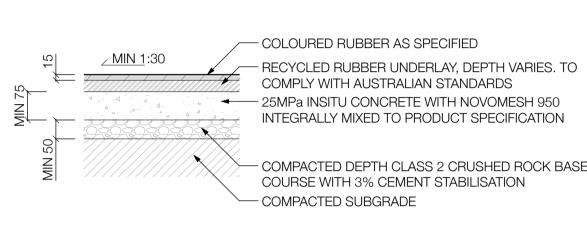

COMPACTED DEPTH CLASS 2 CRUSHED ROCK BASE

WET POUR INTO TIMBER PLAYGROUND MULCH DETAIL

400

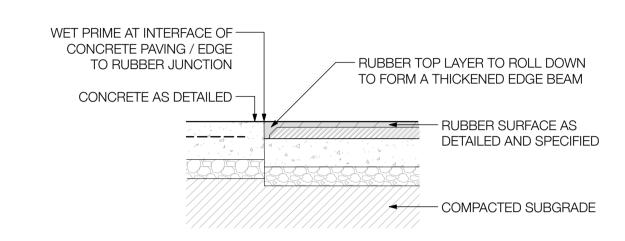

WET POUR AGAINST CONCRETE DETAIL

RUBBER UNDERLAY DEPTH VARIES. INSTALL WITH DEPTH SUFFICIENT TO EXCEED THE FALL HEIGHT OF PLAY EQUIPMENT PLUS MINIMUM 10% TO COMPLY WITH AUSTRALIAN STANDARDS

RUBBER SURFACES TO BE IMPACT TESTED AT INSTALLATION TO CONFIRM CORRECT INSTALLATION AND IMPACT ATTENUATION.

MULCH TO BE MOUNDED AROUND RUBBER SURFACE ACCESS PATH TO BASKET SWING

RUBBER SURFACE TO BE BURIED UNDER 100MM DEPTH OF MULCH AT BASE OF SLIDE AND UNDER TODDLER & JUNIOR SWING SEATS

## RUBBER SOFTFALL (SF05)


1:10 @ A1 | 1:20 @ A3

TYPICAL DETAIL







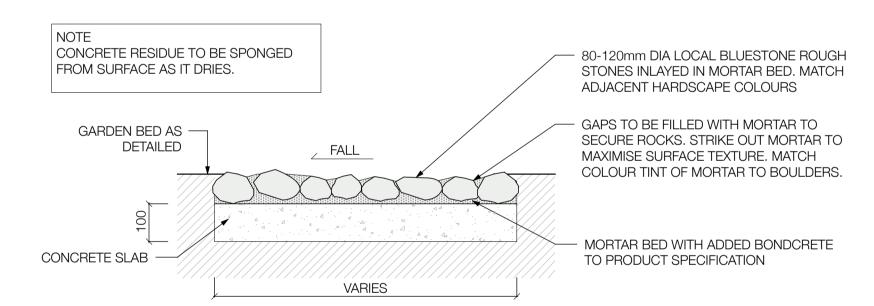

## TIMBER GARDEN MULCH (SF06)

1:10 @ A1 | 1:20 @ A3


## TIMBER GARDEN MULCH (TOP UP) (SF07)


1:10 @ A1 | 1:20 @ A3



TEXTURED STONE SURFACE (SF09) 1:10 @ A1 | 1:20 @ A3

DRAWN **OB** 

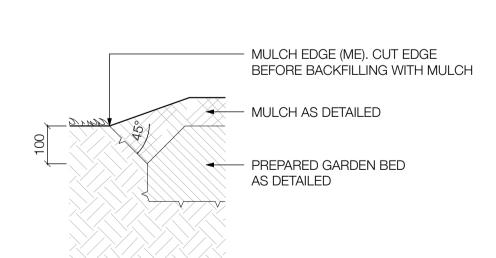

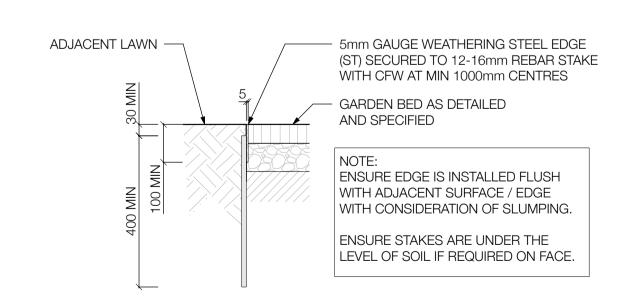

TIMBER PLAYGROUND MULCH AS DETAILED.

MULCH LEVEL TO ALL EDGES TYPICAL

ABOVE RUBBER SURFACE

- TRENCH INTO SUBGRADE

COMPACTED SUBGRADE

ADJACENT SURFACE NOMINALLY 100mm

- RUBBER WET POUR. REFER TYPICAL DETAIL. TO BE

INSTALLED WITH NOMINAL 1:2 SET DOWN BELOW

MULCH EDGE (ME) 1:10 @ A1 | 1:20 @ A3

STEEL EDGE (ST) 1:10 @ A1 | 1:20 @ A3

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## WARNING

FOR CONSTRUCTION

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**PROJECT** YARRALUMLA RESERVE Capital Works

**CLIENT** Frankston City Council 30 Davey Street, Frankston VIC 3199 PLAN NUMBER P355/001

JOB NUMBER

211006

PHASE **Construction Support** 


DRAWING TITLE **Landscape Details**  **REV. COMMENT** DATE ISSUE FOR CONSTRUCTION PACKAGE 02.02.2023

CHECK CC

SCALE AS SHOWN ABOVE


SHEET 24 of 31 DRAWING NO. LCD-901

### K673 'LONGREACH' SHELTER

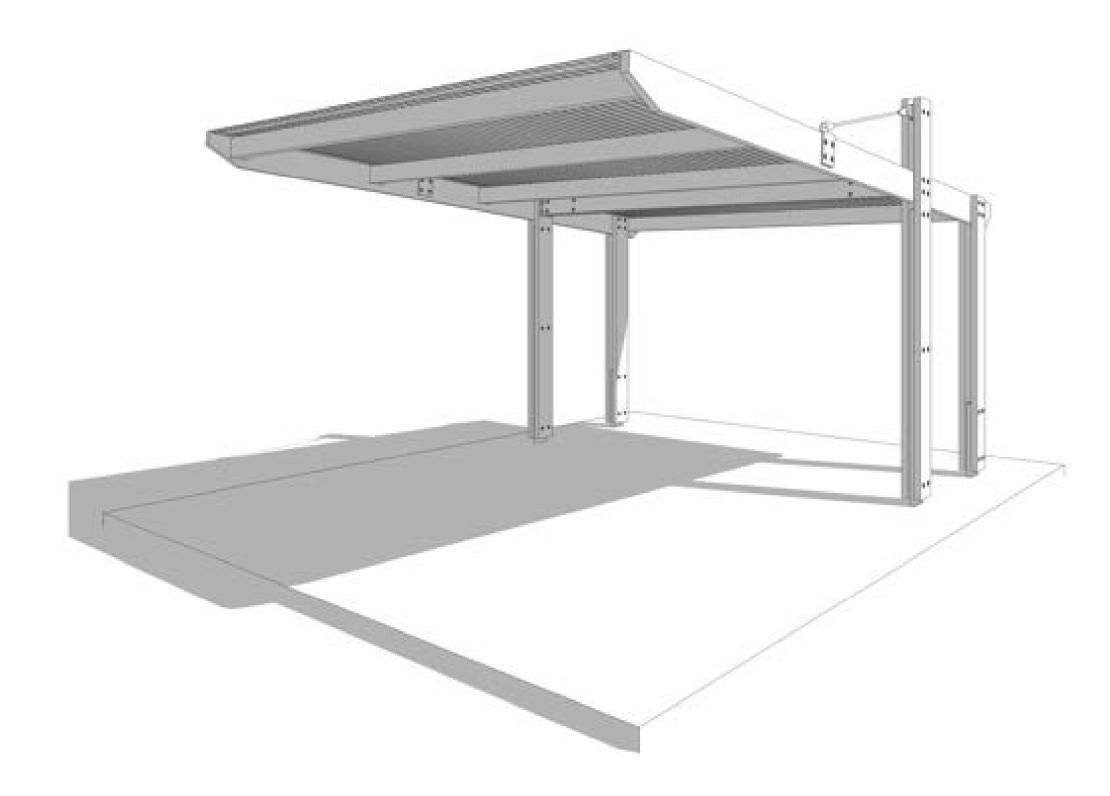

## **GENERAL NOTES**

- DURING CONSTRUCTION THE STRUCTURE SHALL BE MAINTAINED IN A STABLE CONDITION AND NO PART SHALL BE OVER STRESSED.
- PRIOR TO COMMENCEMENT OF WORKS THE BUILDER SHALL SATISFY THEMSELVES OF THE CORRECT LOCATIONS OF ALL EXISTING SERVICES WHETHER INDICATED OR NOT ON THE
- LOCATING OF THE STRUCTURE, INCLUDING CO-ORDINATES IF APPLICABLE, IS THE
- RESPONSIBILITY OF THE CLIENT AND/OR THE CLIENT'S SITE REPRESENTATIVE STRUCTURE HAS BEEN DESIGNED AS A CLASS 10A STRUCTURE & IN ACCORDANCE TO THE
- FOLLOWING AUSTRALIAN STANDARDS: A. AS1170.1, AS1170.2, AS1720.1, AS3600 AND AS4100, AS1664.
- STRUCTURE IS SUITABLE FOR N3 AREAS AND HAS BEEN DESIGNED WITH AN AVERAGE
- RECURRENCE INTERVAL OF 500 YEARS. SITE COVERAGE IS 19.5m<sup>2</sup> (ROOF AREA).
- THE FOOTING HAS BEEN DESIGNED ASSUMING:
- SITE CLASS S OR M
- ALLOWABLE SOIL BEARING CAPACITY OF 100kPa SOIL ADHESION OF 10kPa (TO BE VERIFIED ON SITE).
- FOR SLABS ON GROUND, ALL TOPSOIL AND UPPER STRATA CONTAINING SOFT OR ORGANIC
- MATTER ARE TO BE REMOVED AND REPLACED WITH SELECT COMPACTED FILL. ALL FILL TO BE CLEAN, PLACED IN LAYERS NOT EXCEEDING 200mm AND COMPACTED TO 95% STANDARD COMPACTION.
- EARTHWORKS SHALL BE CARRIED OUT IN ACCORDANCE WITH CRITERIA AND PROCEDURES SET OUT IN AS3798 GUIDELINES ON EARTHWORKS FOR COMMERCIAL AND RESIDENTIAL DEVELOPMENTS.

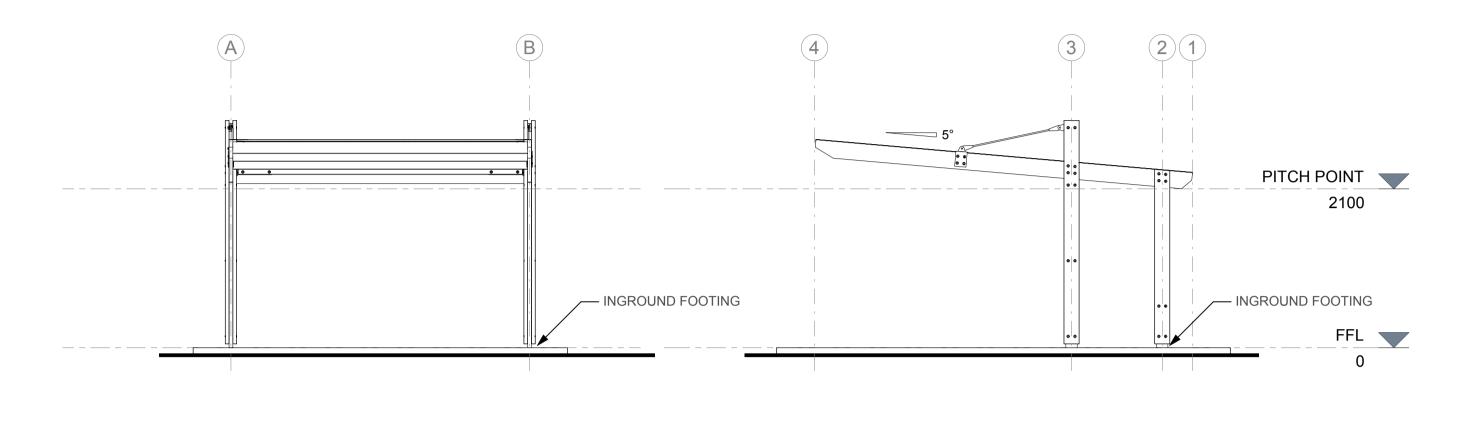

**EAST ELEVATION** 


# LINE OF ROOF OVER LINE OF SLAB PLAN


#### **CONCRETE NOTES**

UNLESS NOTED OTHERWISE, ALL FOOTINGS TO BE FOUNDED 200mm INTO NATURAL GROUND OR CERTIFIED FILL.

FRONT ELEVATION

- UNLESS NOTED OTHERWISE, CONCRETE TO BE 25MPa, 40mm COVER.
- CONCRETE COVER TO BE MAINTAINED BY THE USE OF APPROVED CHAIRS AND/OR CONCRETE BLOCKS SPREAD AT APPROXIMATELY 600mm CROSS CENTRES.
- CONSTRUCTION JOINTS WHERE NOT SHOWN SHALL BE LOCATED TO THE APPROVAL OF
- NO HOLES OR CHASES OTHER THAN THOSE SHOWN ON THE STRUCTURAL DRAWINGS SHALL BE MADE IN CONCRETE MEMBERS WITHOUT THE PRIOR APPROVAL OF THE **ENGINEER**
- ALL CONCRETE SURFACES ARE TO BE CURED BY AN APPROVED METHOD FOR SEVEN DAYS IMMEDIATELY AFTER CONCRETE IS PLACED.
- ALL CONCRETE TO BE MECHANICALLY VIBRATED DURING PLACEMENT.
- ALL WORKMANSHIP AND MATERIALS SHALL BE IN ACCORDANCE WITH CURRENT RELATIVE CODES IN PARTICULAR AS3600 CONCRETE STRUCTURES.
- REINFORCMENT LAPS TO BE AS FOLLOWS: FABRIC: 2 CROSS WIRES + 25mm - TRENCH MESH: 450mm
- 12 BAR: 500mm N16 BAR: 600mm
- N20 BAR: 800mm N24 BAR: 1000mm

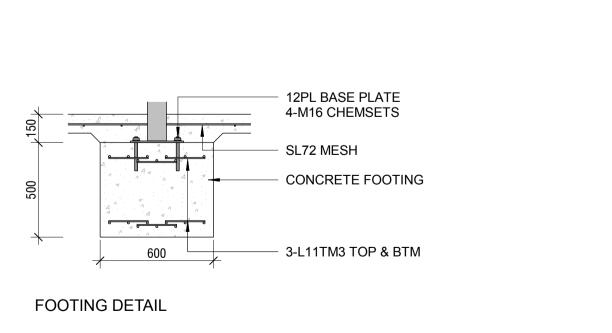

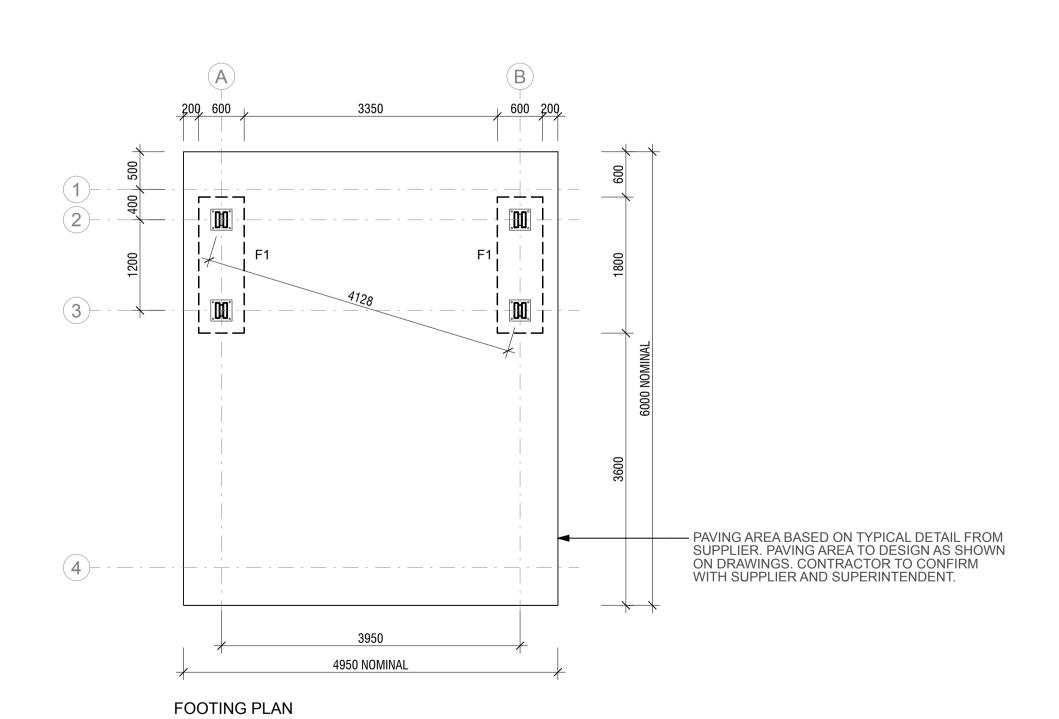

SHELTER (FN01)

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- FOR CONSTRUCTION WARNING
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**PROJECT** YARRALUMLA RESERVE Capital Works

CLIENT Frankston City Council 30 Davey Street, Frankston VIC 3199 PLAN NUMBER PHASE P355/001 **Construction Support** 

211006

JOB NUMBER DRAWING TITLE Landscape Details **REV. COMMENT** DATE ISSUE FOR CONSTRUCTION PACKAGE 02.02.2023

CHECK CC


DRAWN **OB** 

SCALE AS SHOWN ABOVE SHEET

> 25 of 31 DRAWING NO. LCD-902



PICNIC SETTING (FN02)

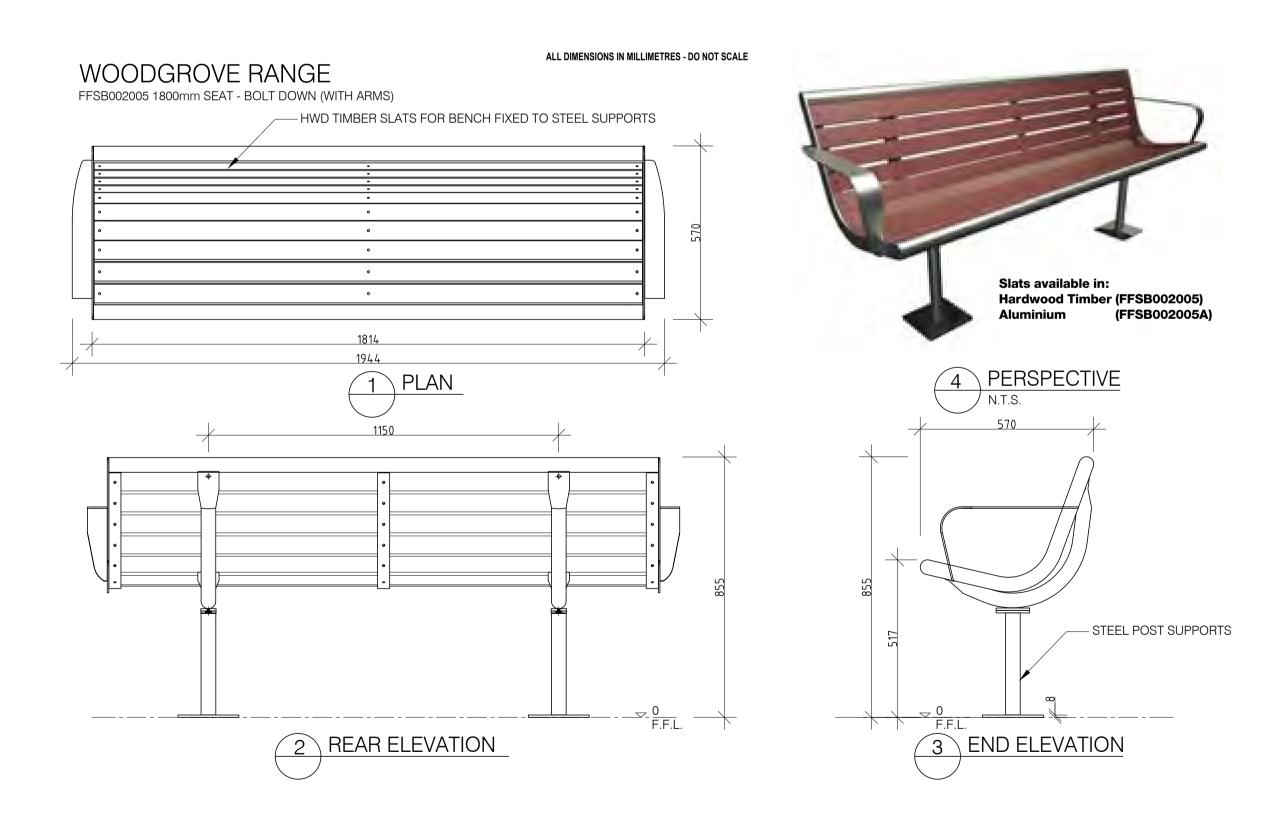

SEAT WITH BACK (FN04)
NTS

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#### PROJECT YARRALUMLA RESERVE


CLIENT Frankston City Council
30 Davey Street, Frankston VIC 3199

P355/001

NTS

Capital Works JOB NUMBER 211006


**Top View** 

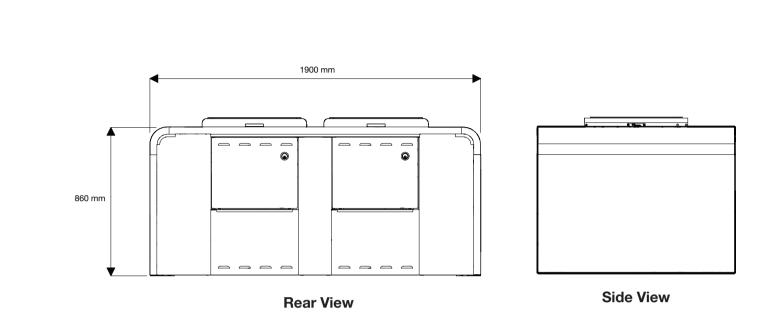

02 BBQ (FN03)

**Dimensions:** Width 1900 mm Depth 1150 mm Height 860 mm

Weight: 172 kg

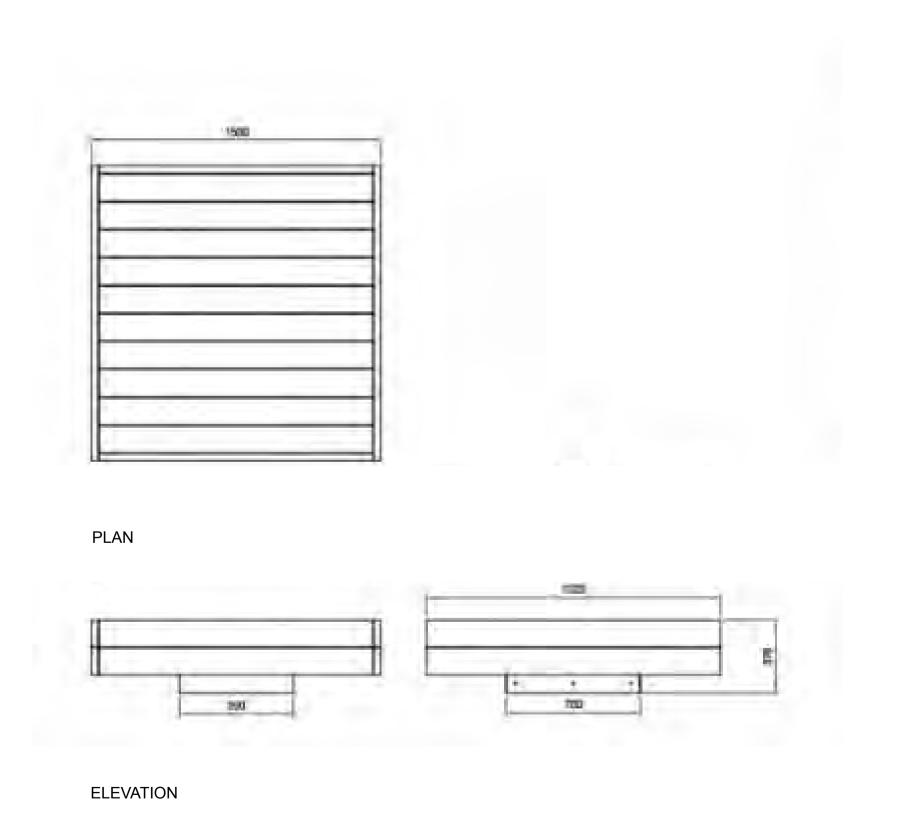

NOTE: Cooktops not included


04 PLATFORM SEAT (FN05)

PLAN NUMBER PHASE

**REV. COMMENT Construction Support** A ISSUE FOR CONSTRUCTION PACKAGE DRAWING TITLE **Landscape Details** DRAWN **OB** CHECK CC

DATE 02.02.2023 26 of 31 DRAWING NO. LCD-903

SCALE AS SHOWN ABOVE SHEET

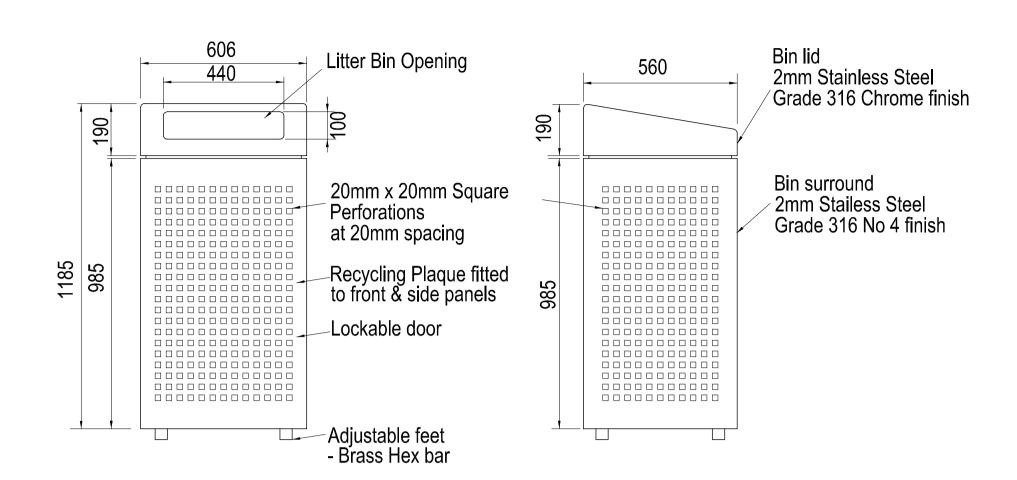


## BIN ENCLOSURE

1. LOCATION:- Determine Position - Refer to court size and line marking 2. FOOTING (HOLE) SIZE:- Depends on local conditions and is determined after soil testing has been completed. Consult your engineer. The following sizes are to be used as a guide only.

600 x 600 x 1200mm Deep Very Hard & Rocky Ground:

3. Position post or post & sleeve in hole. Fit sleeve shroud over post & tape to post approx. 1m high, for slip ring. Ensure post is vertical & add concrete.

4. When concrete is cured, fit tower head (with slip ring). Assemble board, ring and starbracket together on the ground.

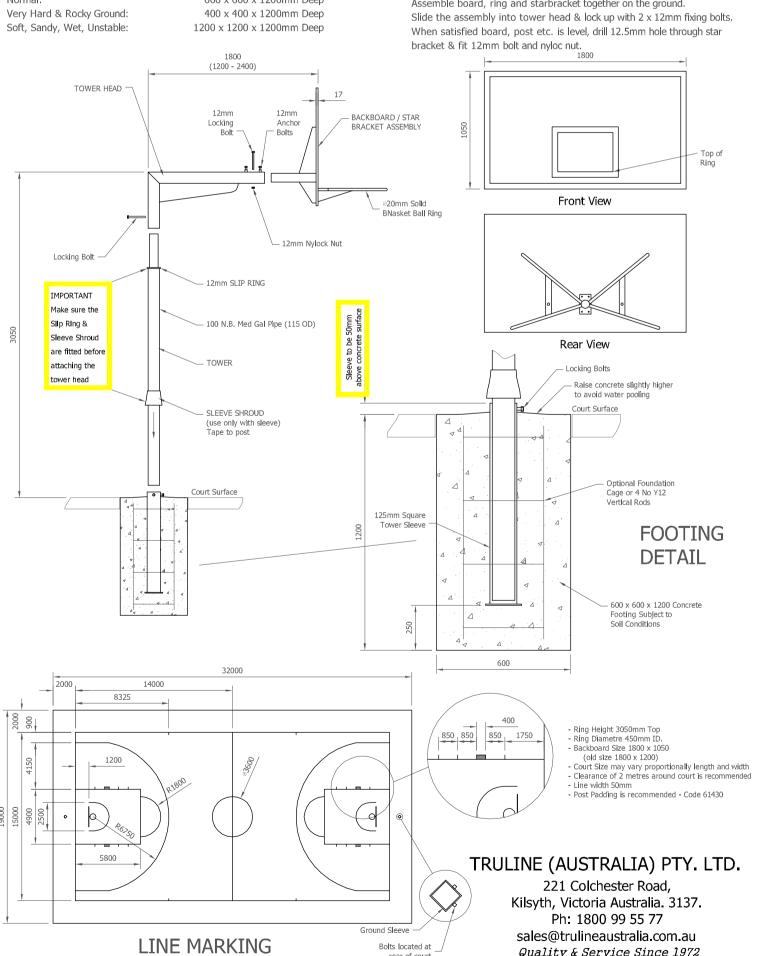



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- Product features • 850mm height WaterMark<sup>™</sup> certified
- One anti-bacterial bottle refill
- One drinking fountain with protective mouth guard
- Stainless steel swinging dog drinking bowl
- · Disability friendly design. Bottle refill complies with AS1428.2 1992 Drainage Pit Two (2) year warranty on the
- Product and a further eight (8) year warranty period Durable stainless steel covering the stainless steel components of the Product type-316 base material design

#### Additional options

- Optional inbuilt water filter Optional sign panel
- Optional inbuilt water meter


#### **Technical Details**

recillical Details	
Housing frame	Stainless steel steel type-316 base material
Housing unit	Anodised aluminium
Graphic panels	Stainless steel
Filter unit	Sub-micron or 5 micron
Filter unit woking pressure	10-125 psi (0.7-8.5 bar), non-shock
Water supply connection	1/2 inch supply line with 1/2 inch Male BSP connection
Drainage	50mm PVC
Drainage cage dimensions	330 x 300 x 400

\*Please refer to the Aquafil® Product Warranty for full terms and conditions

guard drinking point Stainless steel anti-bacterial bulk refill dispenser for bottle refilling Stainless steel drinking basin Optional sign panel Stainless steel frame construction Swinging dog drinking bowl Drainage pit

Rubber mouth

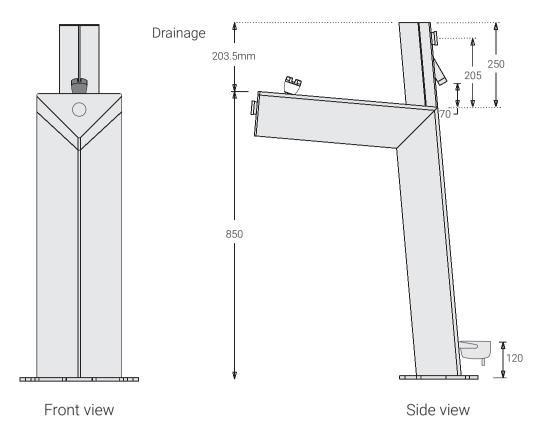




**CIVIQ**<sup>™</sup> Public-use Products 8-10 Giffard Street, Silverwater NSW 2128 W civiq.com.au E sales@civiq.com.au P 1300 600 300


## **DRINKING FOUNTAIN**

**PROJECT** PLAN NUMBER YARRALUMLA RESERVE **Construction Support** P355/001 Capital Works **CLIENT** JOB NUMBER DRAWING TITLE Frankston City Council 211006 **Landscape Details** 30 Davey Street, Frankston VIC 3199

**REV. COMMENT** DATE ISSUE FOR CONSTRUCTION PACKAGE 02.02.2023 CHECK CC DRAWN **OB** 

SCALE AS SHOWN ABOVE SHEET 27 of 31 DRAWING NO. LCD-904

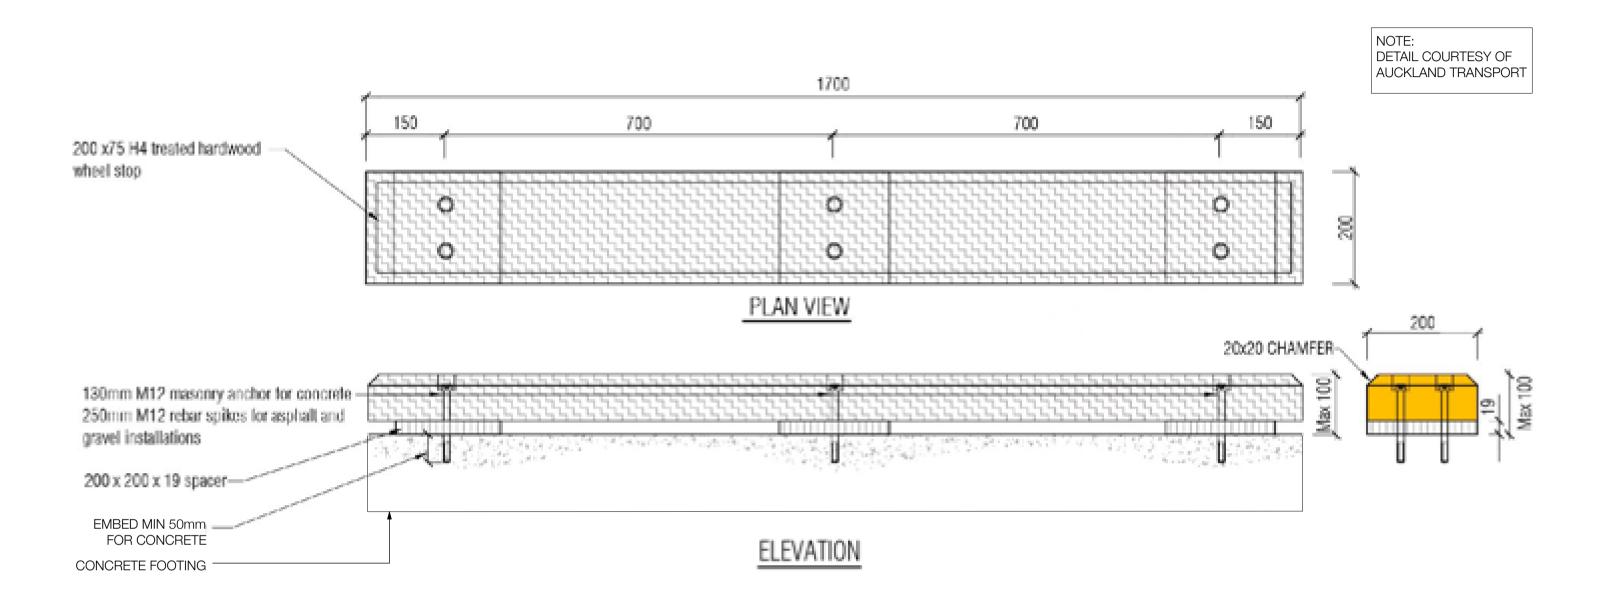


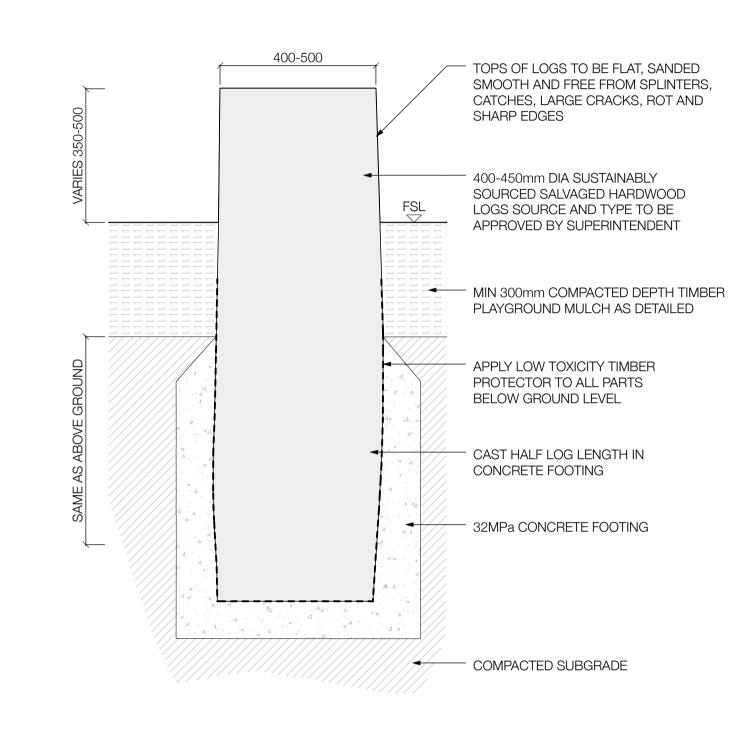


01 TIMBER WHEEL STOP

NTS

1:10 @ A1 | 1:20 @ A3

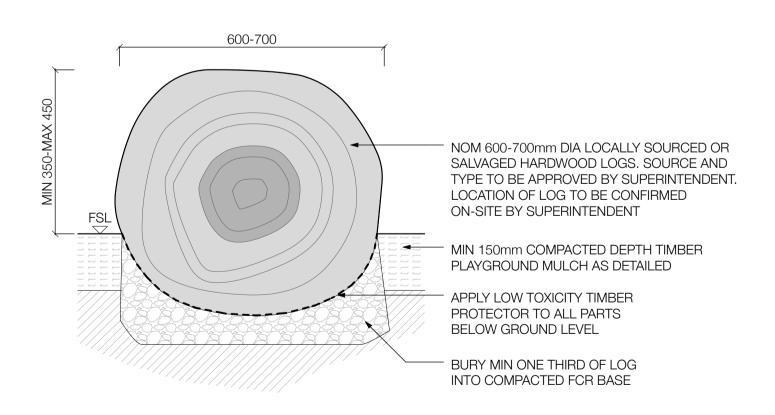

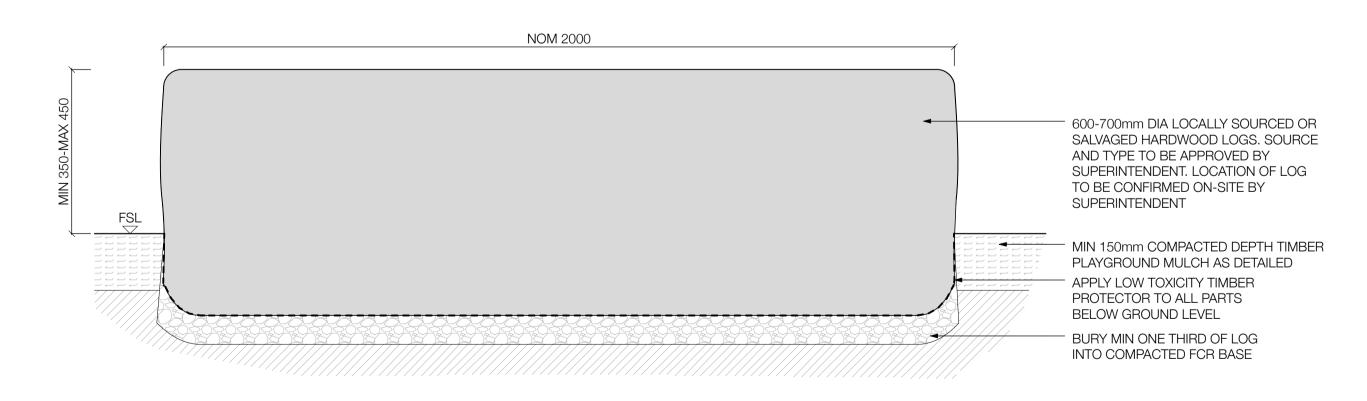

NOTE: LOGS TO BE PLACED ON FIRM BASE. ANY LOGS THAT MOVE WILL BE REJECTED.

LOGS TO BE DEBARKED PRIOR TO INSTALLATION AND ALL EDGES ROUNDED OFF.

03 LOG SEAT 1:10 @ A1 | 1:20 @ A3

Pollen Studio Ptv Ltd - Landscape Architect

Pollen Studio Pty Ltd - Landscape Architects BRUNSWICK - Siteworks Studio 1 | Level 1 | 33 Saxon Street VIC 3056 03 9329 7548 | pollen@pollenstudio.com.au pollenstudio.com.au | ABN 45 494 020 124 WARNING

FOR CONSTRUCTION

- Beware of underground services. Locations of underground services

are indicative only. Their exact position should be proven on site.Contractor to verify all dimensions on site before commencing work.Report all discrepancies to Superintendent prior to construction.

Figured dimensions to be taken in preference to scaled drawings.
All drawings may not be distributed without prior permission from the Landscape Architect. PROJECT
YARRALUMLA RESERVE
Capital Works

CLIENT
Frankston City Council
30 Davey Street, Frankston VIC 3199

PLAN NUMBER P355/001

JOB NUMBER

211006

DRAWING TITLE

Landscape Details


REV. COMMENT
A ISSUE FOR CONSTRUCTION PACKAGE
02.02.2023

CHECK CC


DRAWN **OB** 

SCALE AS SHOWN ABOVE SHEET

SHEET
28 of 31
DRAWING NO.
LCD-905

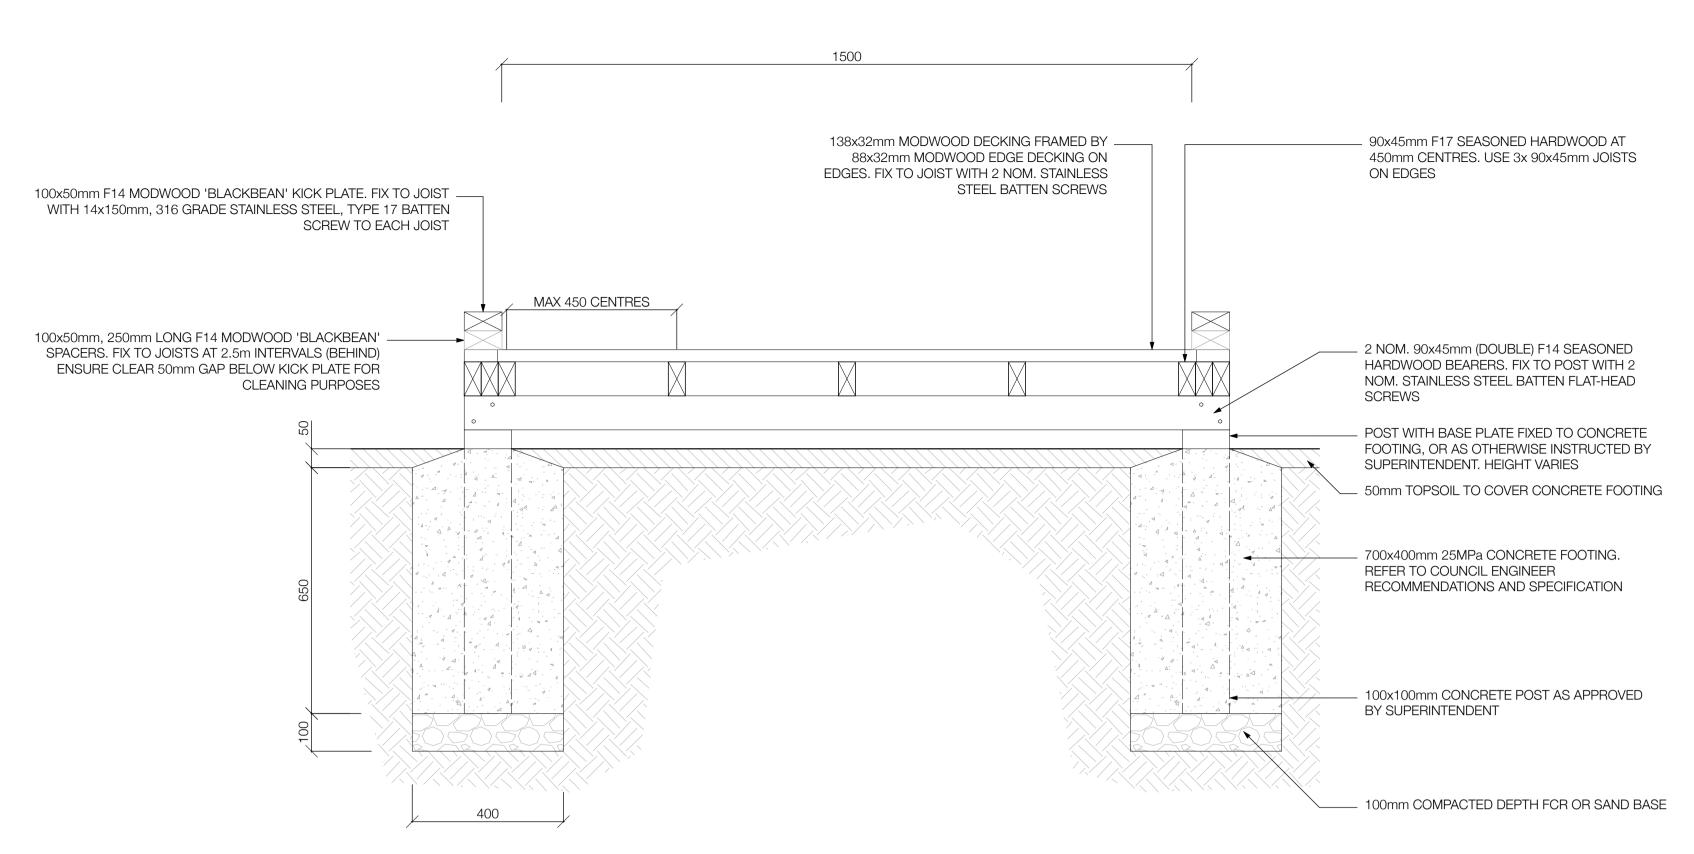

TYPICAL DETAIL

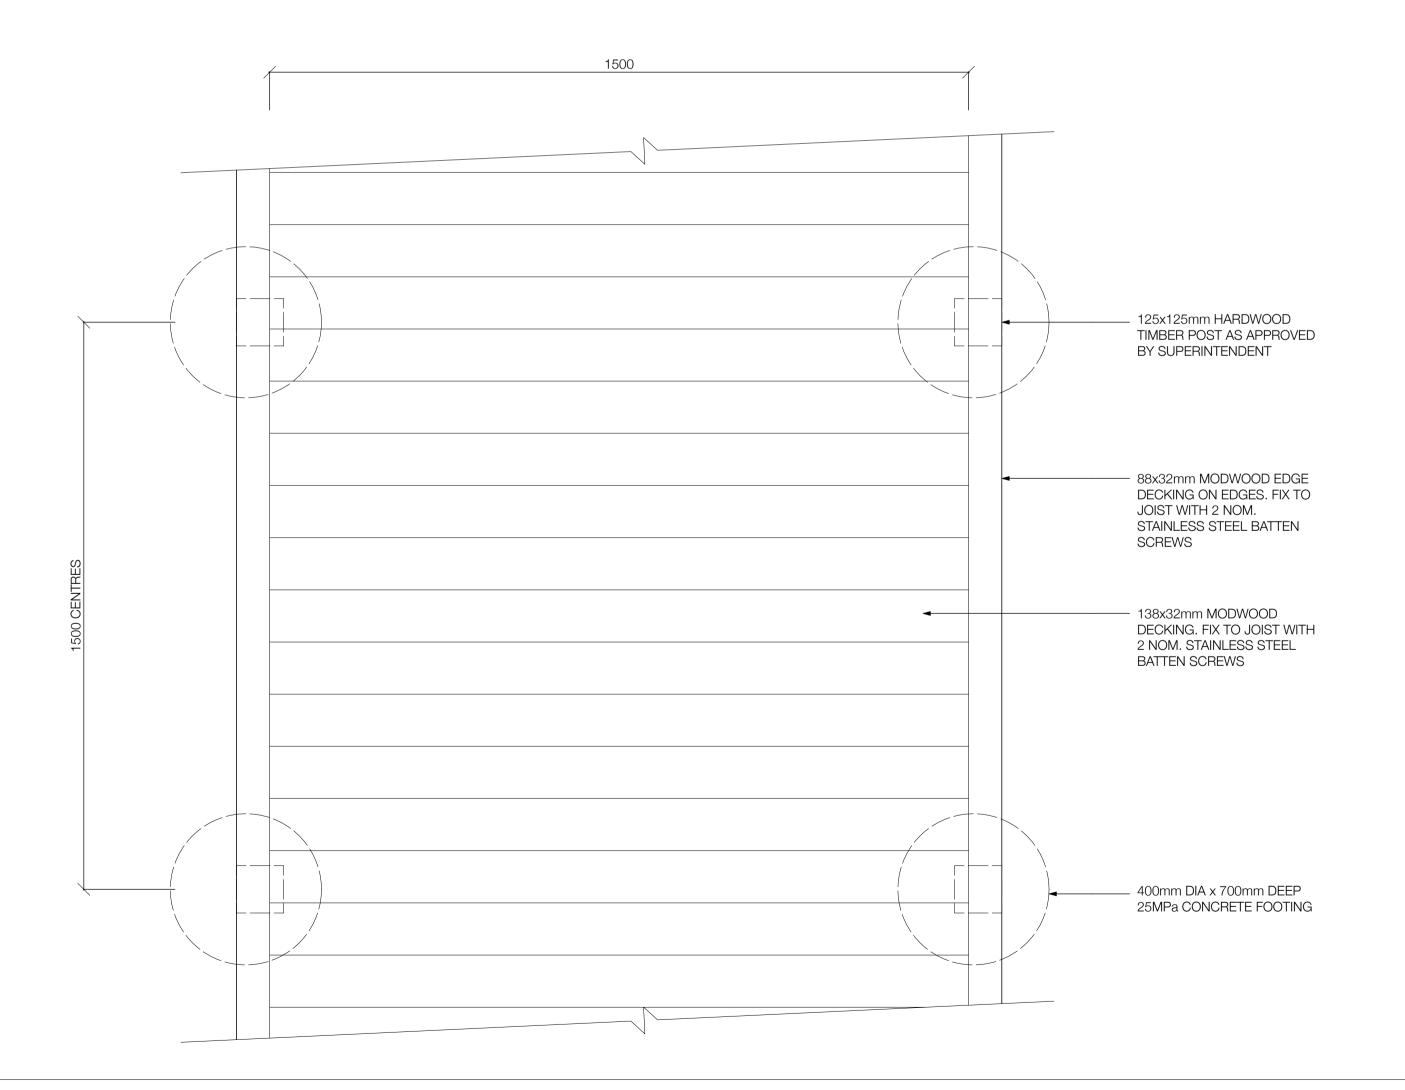

01 BRIDGE (PEDESTRIAN) (ST01) 1:10 @ A1 | 1:20 @ A3

PLAN

POLLEN

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BRUNSWICK - Siteworks
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03 9329 7548 | pollen@pollenstudio.com.au
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PROJECT
YARRALUMLA RESERVE
Capital Works

CLIENT
Frankston City Council
30 Davey Street, Frankston VIC 3199

PLAN NUMBER PHASE
P355/001 Construction Support

JOB NUMBER

211006

DRAWING TITLE

Landscape Details


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A ISSUE FOR CONSTRUCTION PACKAGE
02.02.2023

CHECK CC

DRAWN **OB** 

SCALE AS SHOWN ABOVE SHEET


SHEET
29 of 31
DRAWING NO.
LCD-906

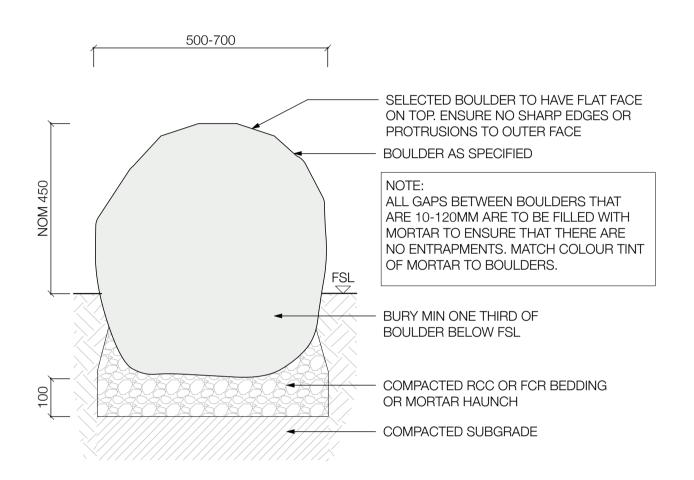

--- ALL GAPS BETWEEN 10-120mm ARE TO BE CUT-TOP BOULDER — BOULDER AS AS DETAILED DETAILED FILLED WITH MORTAR TO ENSURE THAT THERE ARE NO ENTRAPMENTS. MATCH COLOUR TINT OF MORTAR TO BOULDERS COMPACTED SUBGRADE - COMPACTED RCC OR FCR BEDDING OR MORTAR HAUNCH


HOT DIPPED GALVANISED STEEL

HOOPS

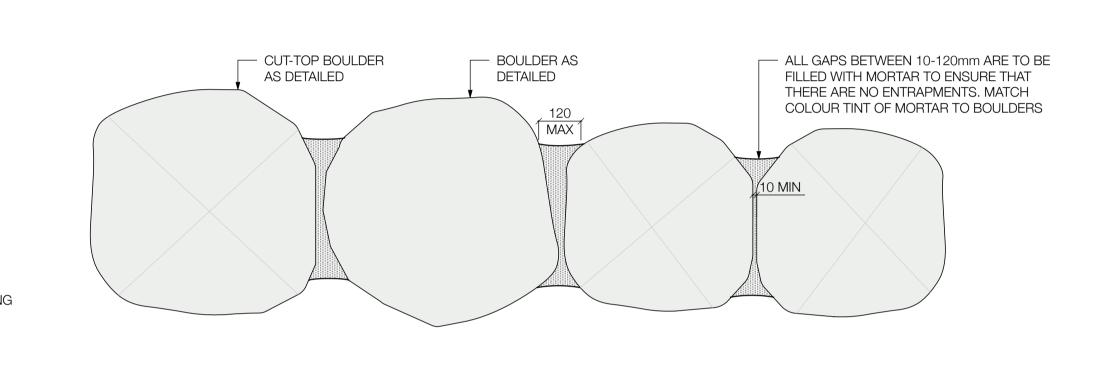

## MEDIUM BOULDER WITH BEDDING TYPICAL DETAIL

**ELEVATION** 

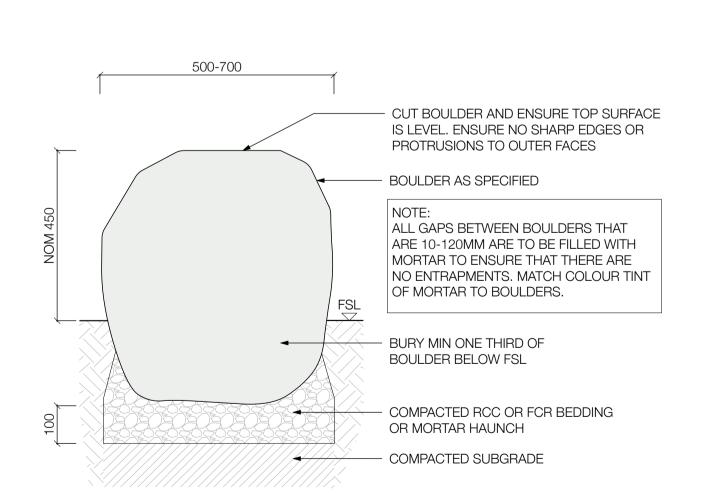

MEDIUM BOULDER BENCH TYPICAL DETAIL



**DOINT BOULDER BENCH** 

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pollenstudio.com.au | ABN 45 494 020 124

WARNING

TACK WELD HOOPS TOGETHER

AFTER INSTALLATION

- Beware of underground services. Locations of underground services

ROUND

- are indicative only. Their exact position should be proven on site. - Contractor to verify all dimensions on site before commencing work. - Report all discrepancies to Superintendent prior to construction.
- Figured dimensions to be taken in preference to scaled drawings. - All drawings may not be distributed without prior permission from the Landscape Architect.
- YARRALUMLA RESERVE Capital Works

CLIENT Frankston City Council 30 Davey Street, Frankston VIC 3199 PLAN NUMBER P355/001

JOB NUMBER

211006

**Landscape Details** 

DRAWING TITLE

DRAWN **OB** 


PLAN


DATE ISSUE FOR CONSTRUCTION PACKAGE 02.02.2023


CHECK CC

SHEET 30 of 31 DRAWING NO.

LCD-907

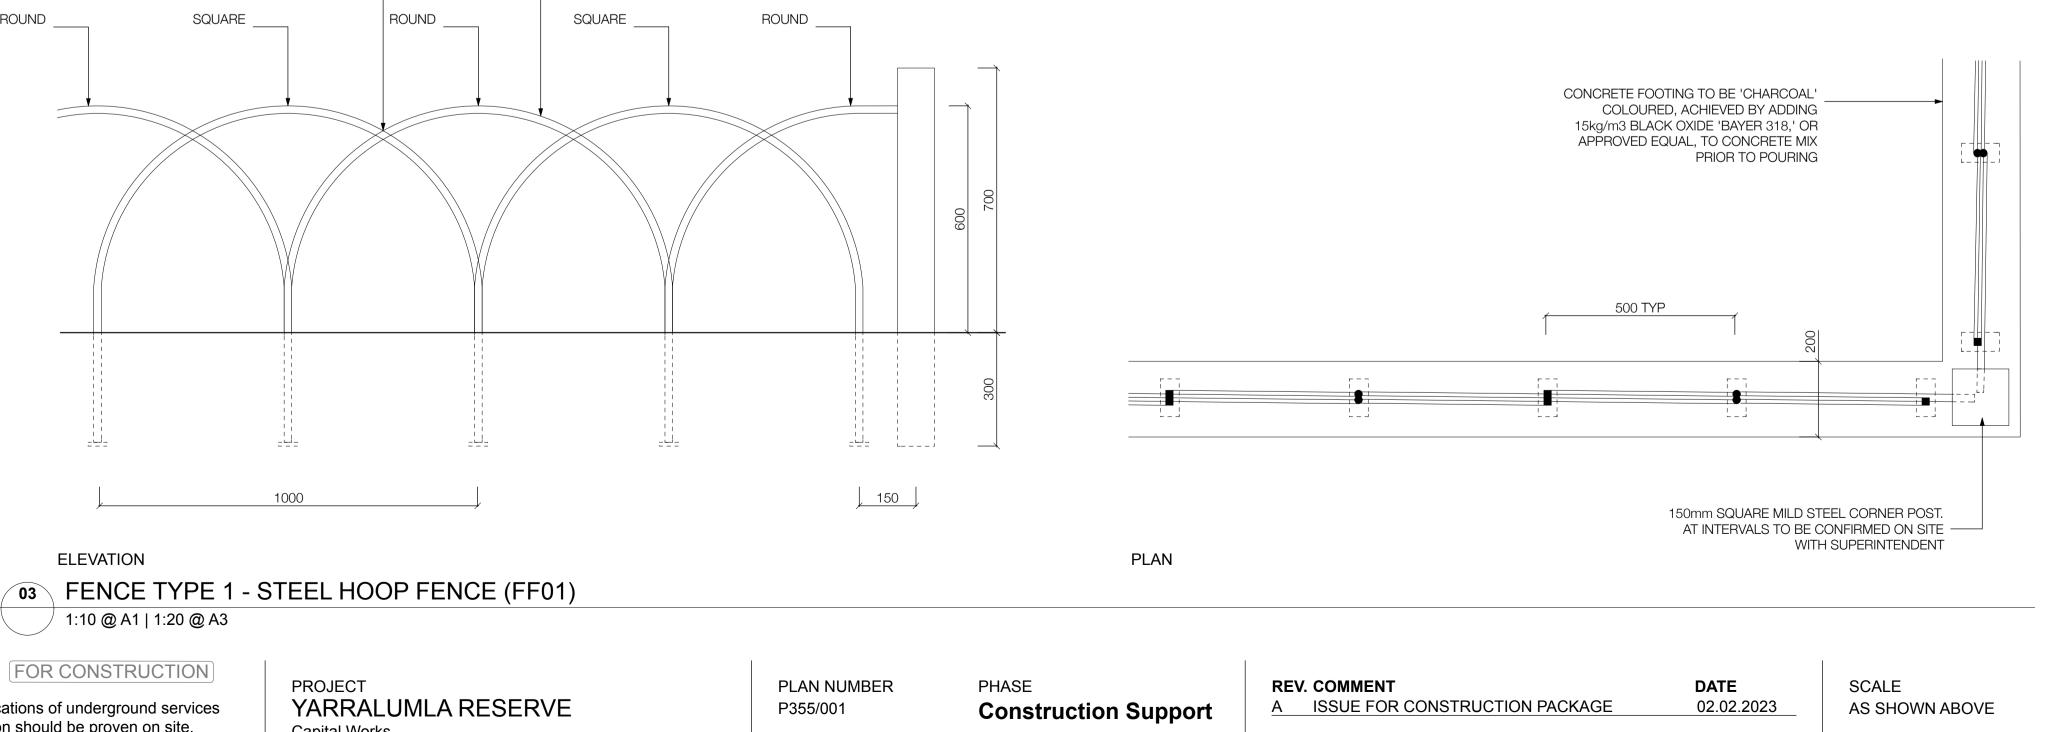

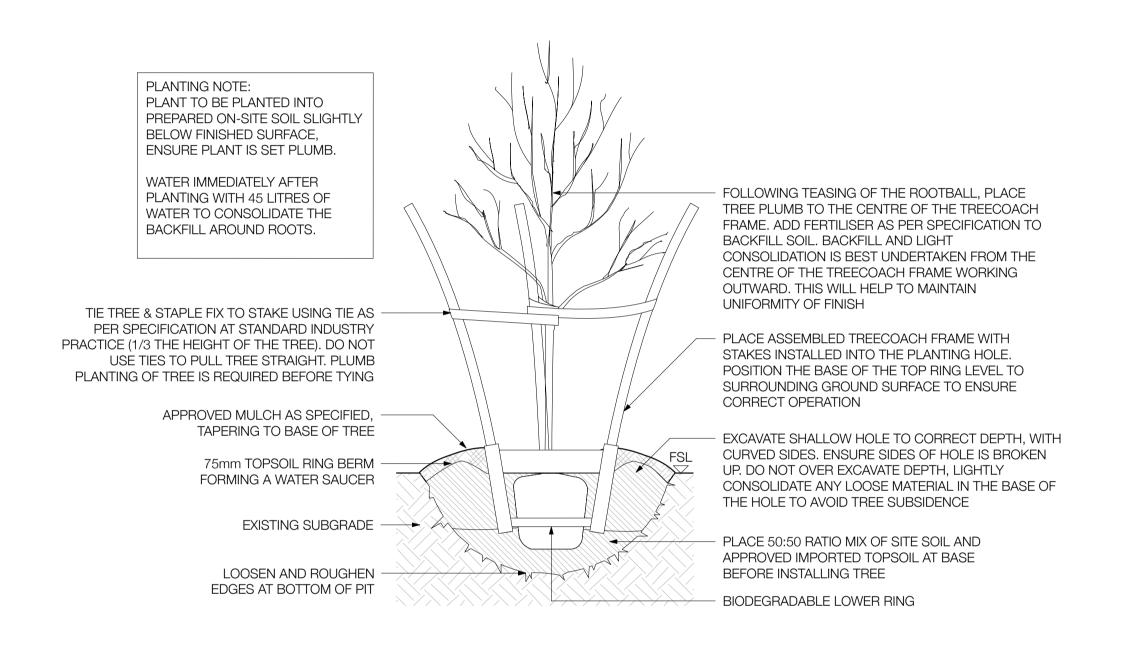


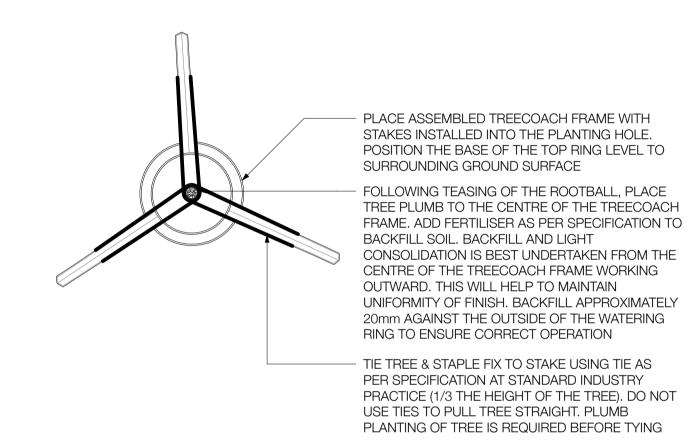

SECTION PLAN

### TREE PLANTING WITH TREE COACH

1:20 @ A1 | 1:40 @ A3

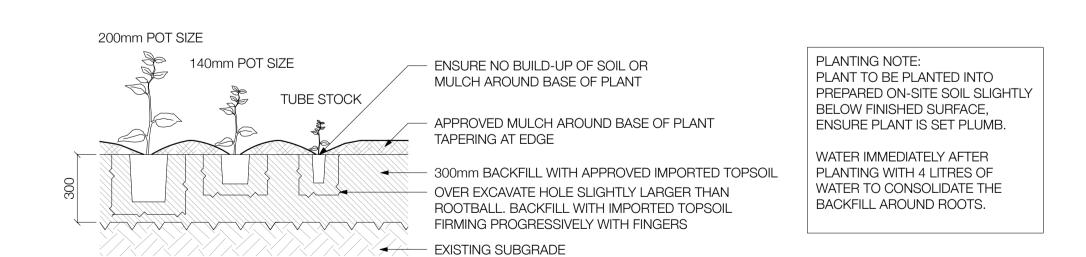





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WARNING
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YARRALUMLA RESERVE
Capital Works

Frankston City Council

30 Davey Street, Frankston VIC 3199

**CLIENT** 

PLAN NUMBER PHASE
P355/001 Construction Support

JOB NUMBER DRAWING TITLE
211006 Landscape Details

REV. COMMENT
A ISSUE FOR CONSTRUCTION PACKAGE

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SCALE
AS SHOWN ABOVE
SHEET
31 of 31
DRAWING NO.

LCD-908